



# SOLLERS POINT MULTIPURPOSE CENTER TURF AND TRACK REPLACEMENT

323 SOLLERS POINT RD, DUNDALK, MARYLAND 21222

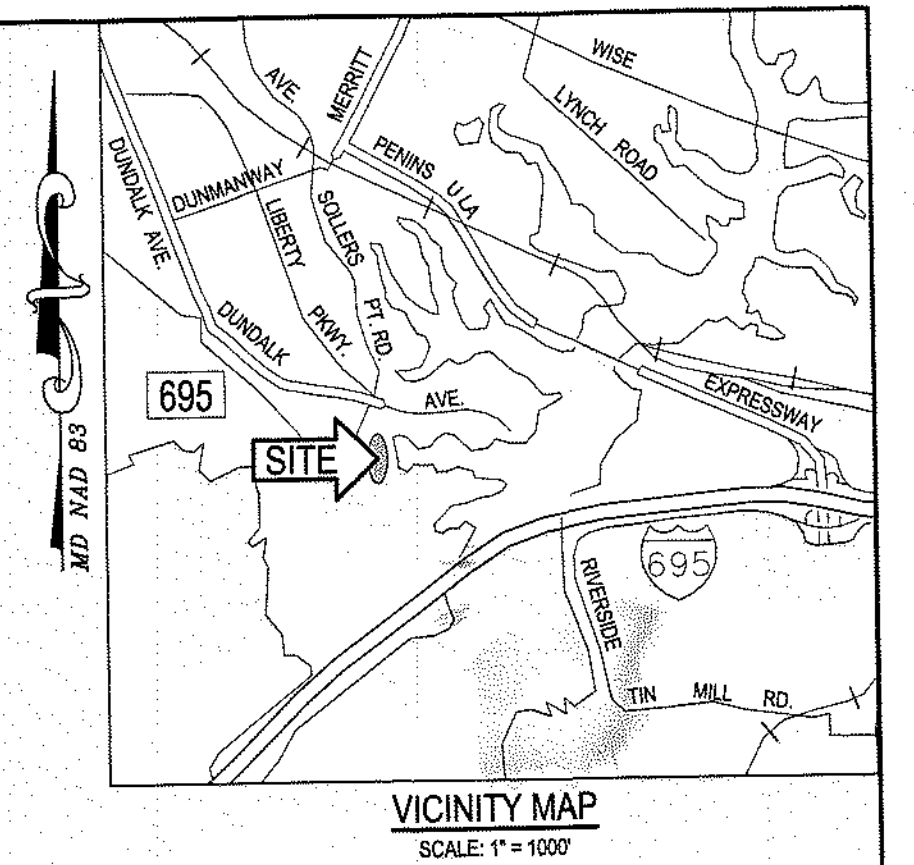

## GENERAL NOTES

- THIS PLAN IS BASED UPON A FIELD-RUN TOPOGRAPHIC SURVEY PERFORMED BY WBCM IN MAY, 2020 AND REFLECTS SITE CONDITIONS AS OF THAT DATE.
- COORDINATES AND DIRECTIONS SHOWN HEREON ARE REFERRED TO THE MARYLAND STATE PLANE COORDINATE SYSTEM, NAD 83/2011 AS DETERMINED FROM REAL TIME KINEMATIC SURVEYING AS BROADCAST BY THE LEICA SMARTNET NETWORK.
- ELEVATIONS SHOWN HEREON ARE REFERRED TO THE NORTH AMERICAN VERTICAL DATUM OF 1988 (NAVD 88), AS DETERMINED BY R.T.K. G.P.S. OBSERVATIONS AS BROADCAST BY THE LEICA SMARTNET NETWORK(GEIOD18).
- ADDITIONAL SPOT ELEVATIONS RESIDE IN THE ELECTRONIC VERSION OF THIS DRAWING BUT ARE NOT PLOTTED HEREON.
- THE LOCATION OF EXISTING UNDERGROUND UTILITIES IS SHOWN IN AN APPROXIMATE WAY ONLY. THE DESCRIPTION OF THE UNDERGROUND UTILITIES AS SHOWN HEREON WERE BASED SOLELY UPON FIELD OBSERVATIONS AND HAVE NOT BEEN COMPARED TO OR VERIFIED WITH RECORD UTILITY DRAWINGS OR FIELD TEST PITS. THE SIZE, TYPE AND LOCATION OF THE UTILITY LINES SHOULD BE VERIFIED BY THE USER OF THIS DRAWING.
- IT IS THE CONTRACTOR'S RESPONSIBILITY TO FIELD VERIFY ACTUAL SITE CONDITIONS PRIOR TO THE START OF ANY WORK. THERE IS NO WARRANTY OR GUARANTEE ON THE COMPLETENESS OR CORRECTNESS OF THE EXISTING CONDITION INFORMATION. ANY DISCREPANCY FOUND SHALL BE BROUGHT TO THE IMMEDIATE ATTENTION OF THE ARCHITECT/ENGINEER PRIOR TO THE START OF ANY WORK.
- THE CONTRACTOR SHALL BE RESPONSIBLE FOR NOTIFYING "MISS UTILITY" AT 1-800-287-7777 THREE DAYS PRIOR TO THE START OF ANY EXCAVATION WORK.
- THE CONTRACTOR SHALL STAKE-OUT ALL BASELINES OF CONSTRUCTION AND THE LOCATION OF ALL NEW CONSTRUCTION, AND VERIFY ALL SETBACKS, OFFSETS, AND CLEARANCES PRIOR TO START OF ANY WORK.
- THE CONTRACTOR SHALL VERIFY ALL EXISTING UTILITY INVERTS AND CLEARANCES FROM NEW WORK PRIOR TO START OF ANY WORK.
- ALL DISTURBED AREAS NOT STABILIZED WITH STRUCTURES, PAVING, STONE OR PLANTINGS SHALL BE STABILIZED WITH FOUR INCHES OF TOPSOIL, SEED, MULCH, AND WATER TO ESTABLISH AN ADEQUATE GROWTH OF GRASS.
- ALL WORK SHALL BE ACCOMPLISHED IN ACCORDANCE WITH THE REQUIREMENTS OF THE PROJECT SPECIFICATIONS.
- THE TOPS OF ALL FRAMES, GRATES, AND COVERS OF ALL EXISTING UTILITIES TO REMAIN WITHIN THE LIMITS OF CONTRACT AND/OR DISTURBANCE SHALL BE ADJUSTED TO THE NEW GRADES.
- CONTRACTOR SHALL MAINTAIN POSITIVE DRAINAGE AT ALL TIMES AND SHALL PROVIDE ALL NEEDED LABOR, EQUIPMENT, AND MATERIALS TO PROTECT THE PROJECT SITE FROM PONDING WATER AND FLOODING.
- NUMERICAL DIMENSIONS AND ELEVATIONS SHOWN SHALL SUPERSEDE ANY DISCREPANCY IN THE SCALING ON THE DRAWINGS.
- CONTRACTOR SHALL SUBMIT, FOR REVIEW AND APPROVAL, A WORK PLAN ADDRESSING TRAFFIC CONTROL FOR VEHICLES AND PEDESTRIAN, AND LAYDOWN AND STAGING AREAS FOR EQUIPMENT AND MATERIALS.

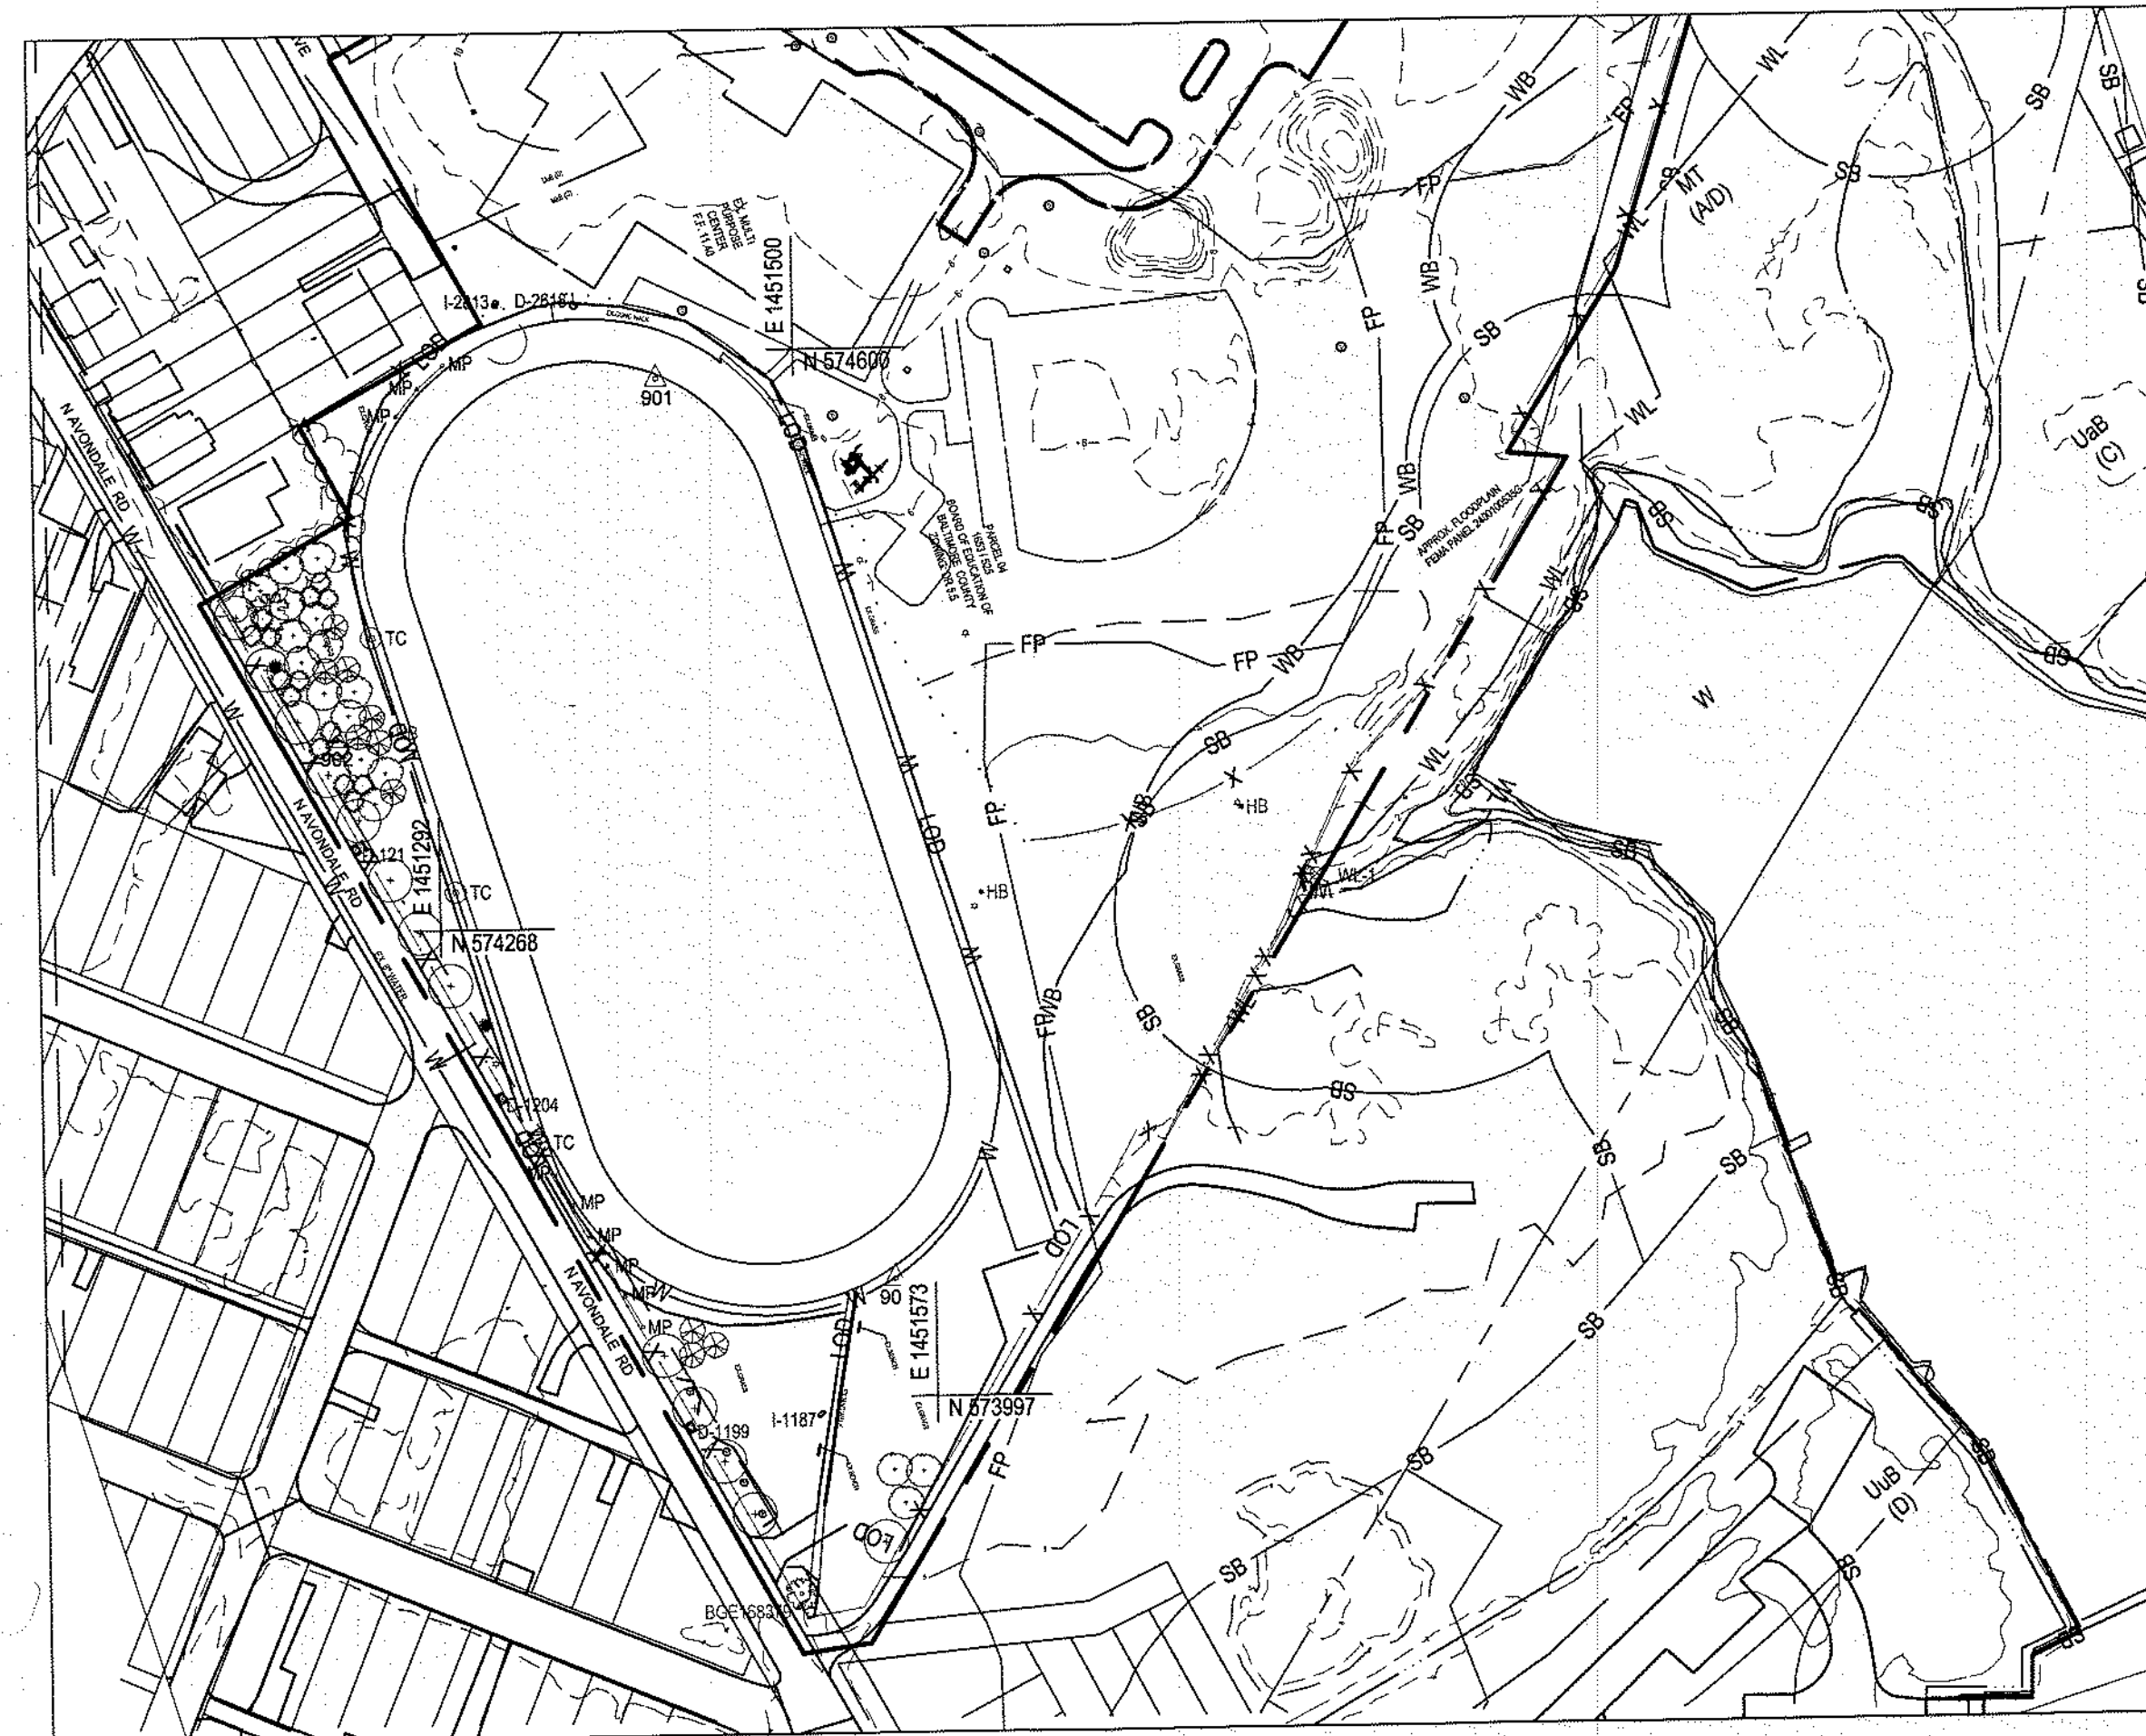

LOCATION MAP  
SCALE: 1"=100'

W.B.C.M. SURVEY TRAVERSE CONTROL LISTING  
PT# NORTHING EASTING ELEV. DESCRIPTION  
900 574,064.44 1,451,549.92 5.15 REBAR & CAP  
901 574,583.72 1,451,420.83 5.79 REBAR & CAP  
902 574,378.35 1,451,234.22 4.79 REBAR & CAP

SHEET NUMBER	DRAWING NUMBER
1	T100
2	C100
3	C101
4	C200
5	C201
6	C301
7	C302
8	C401
9	C501
10	C502
11	C503
12	C504
13	C505
14	C506
15	C507

## DRAWING LIST: DRAWING TITLE

CIVIL:  
COVER SHEET  
EXISTING CONDITIONS PLAN  
DEMOLITION PLAN  
SITE LAYOUT PLAN  
SITE DETAILS  
GRADING AND UTILITY PLAN  
GRADING AND UTILITY PLAN  
UTILITY PROFILES  
EROSION AND SEDIMENT CONTROL PLAN  
EROSION AND SEDIMENT CONTROL NOTES  
EROSION AND SEDIMENT CONTROL NOTES  
EROSION AND SEDIMENT CONTROL DETAILS  
EROSION AND SEDIMENT CONTROL DETAILS  
BUFFER MANAGEMENT PLAN  
BUFFER MANAGEMENT PLAN

UTILITY SCHEDULE	MH#	TOP	DIR.	INVERT	SIZE & TYPE
I-1000		5.48	S/E	3.04	4" TERRA
			S/W	1.80	8" TERRA
			N/E	1.67	8" TERRA
I-1008		5.47	S	3.36	4" TERRA
			N/E	2.57	8" TERRA
I-1015		5.56	S/W	3.19	4" TERRA
			N/W	2.71	8" TERRA
I-1022		5.53	S/W	2.95	4" TERRA
			S/E	2.23	8" TERRA
			N/E	2.31	8" TERRA
I-1029		5.58	S/W	3.27	4" TERRA
			S/E	2.24	8" TERRA
I-1036		5.52	S/W	3.16	4" TERRA
			S/E	2.57	8" TERRA
I-1043		5.40	S/W	3.28	4" TERRA
			N/W	2.60	8" TERRA
I-1051		5.54	S/W	3.12	4" TERRA
			S/E	2.23	8" TERRA
			N	2.15	8" TERRA
I-1058		5.45	S/W	3.12	4" TERRA
			N/E	2.22	8" TERRA
I-1066		5.48	S/W	3.30	4" TERRA
			S/E	2.61	8" TERRA
I-1073		5.40	S/W	3.19	4" TERRA
			N/E	2.75	8" TERRA
I-1080		5.47	N/W	3.25	4" TERRA
			S/W	2.47	8" TERRA
			N/E	2.43	8" TERRA
I-1088		5.42	N/W	3.16	4" TERRA
			E	2.19	8" TERRA
			S/W	2.16	8" TERRA
			N/E	2.15	8" TERRA
I-1096		5.41	N	3.28	4" TERRA
			S	2.62	8" TERRA
			W	2.55	8" TERRA
I-1104		5.48	N/E	3.09	4" TERRA
			S/E	2.40	8" TERRA
I-1111		5.52	N/E	3.22	4" TERRA
			N/W	2.30	8" TERRA
			S/E	2.33	8" TERRA

UTILITY SCHEDULE	MH#	TOP	DIR.	INVERT	SIZE & TYPE
I-1119		5.45	N/E	3.18	4" TERRA
			N/W	1.98	8" TERRA
			S/E	1.84	8" TERRA
I-1126		5.45	N/E	3.19	4" TERRA
			N/W	1.99	8" TERRA
			S/E	2.04	8" TERRA
I-1134		5.41	N/E	3.09	4" TERRA
			S/W	2.46	8" TERRA
			N/W	2.36	8" TERRA
I-1142		5.46	N/E	3.32	4" TERRA
			S/E	2.64	8" TERRA
I-1149		5.43	N/E	3.00	4" TERRA
			N/W	2.31	8" TERRA
			S/E	2.26	8" TERRA
I-1156		5.49	N/E	2.95	4" TERRA
			S/W	2.36	6" TERRA
			N/W	1.91	8" TERRA
			S/E	1.89	8" TERRA
I-1165		5.49	N/E	3.25	4" TERRA
			S/E	2.25	8" TERRA
			N/W	2.15	8" TERRA
I-1173		5.46	S/E	3.20	4" TERRA
			N	2.68	8" TERRA
I-1180		5.46	S/E	2.99	4" TERRA
			S/W	2.56	8" TERRA
I-1187		3.49	N	1.68	12" MTL
D-1199		5.05	W	2.19	15" RCP
D-1204		4.82	S/W	0.36	18" RCP
			S/W	0.34	27" RCP
			N/E	0.24	32x28" CMP
D-1215		4.40	S/W	1.87	12" CMP
			N/E	2.04	15" CMP
I-2084		5.60	S/W	3.30	4" TERRA
			N/W	2.24	8" TERRA
			S/E	2.25	8" TERRA
D-2618		6.09	S/W	1.54	9" PVC
			S/W	1.44	9" MTL
			N/E	1.34	9" MTL
I-2813		4.74			FILLER CLOTH COVERED

PNW = PIPES NOT VISIBLE  
NOTE: THE ABOVE INFORMATION REFLECT FIELD MEASUREMENTS & OBSERVATIONS AND THEY MAY DIFFER FROM PLANS BY OTHERS.(SEE GENERAL NOTES)

BALTIMORE COUNTY ATT 09/15/2021  
DEPARTMENT OF ENVIRONMENTAL PROTECTION  
AND SUSTAINABILITY  
APPROVED FOR GRADING  
Date 09.15.21

Baltimore County Soil Conservation District  
APPROVED FOR SEDIMENT CONTROL 9/15/21  
Date  
District OFFICIAL  
Plan No. 153-4448-21  
Technical Review for the District by:  
Amy Muscelman  
This plan approval will expire three (3) years from the approval date.

CAUTION:  
IF THIS DRAWING IS A REDUCTION,  
USE THE GRAPHIC SCALES.  
1"=100'-0" 0 50 100 200




OWNER  
PROPERTY MANAGEMENT, CAPITAL SERVICES  
12200 LONG GREEN PIKE  
GLEN ARM, MD 21057  
BRIAN MCKINLEY  
410-887-2915  
SITE ADDRESS:  
323 SOLLERS POINT RD, DUNDALK, MD 21222  
COORDINATES SHOWN HEREON ARE REFERRED TO THE MARYLAND  
STATE PLANE COORDINATE SYSTEM, NAD 83 (1983)  
ELEVATIONS SHOWN HEREON ARE REFERRED TO THE NORTH AMERICAN  
VERTICAL DATUM OF 1988 (NAVD 88).

CONTRACT COMPLETION BOX  
CONTRACTOR:  
DATE COMPLETED:  
INSPECTOR:  
PIPE MATERIAL (Pressure Only):

SHEET DESIGNATION 2021-2869 CONTRACT NUMBER 22005 POO  
JOB ORDER NUMBER 242-212-307-0472  
SHEET 1 OF 15  
DRAWING NUMBER T100  
FILE NO. 450

PROFESSIONAL CERTIFICATION  
I HEREBY CERTIFY THAT THESE DOCUMENTS WERE PREPARED OR APPROVED BY ME, AND THAT I AM A DULY LICENSED PROFESSIONAL ENGINEER UNDER THE LAWS OF THE STATE OF MARYLAND.  
LICENSE NO. 34682 EXPIRATION DATE 07/08/23  
ENGINEER: BLAINE LINKOUS  
DESIGNING INFRASTRUCTURE FOR TOMORROW  
WBCM  
DGN BY: K.H.  
DWN BY: H.H.  
CHKD BY: B.L.  
BUREAU OF ENGINEERING AND CONSTRUCTION  
TRAFFIC  
HIGHWAYS  
STRUCTURES  
STORM DRAINS  
SEWER  
WATER  
FIELD ENGINEER  
DEPARTMENT OF PUBLIC WORKS  
APPROVED BY: DIRECTOR  
DATE:  
APPROVED BY: CHIEF  
DATE:  
SUBDIVISION: SOLLERS POINT  
BALTIMORE COUNTY OFFICE OF BUDGET AND FINANCE, PROPERTY MANAGEMENT  
FIELD, TRACK, AND DRAINAGE REPLACEMENT  
TITLE SHEET  
SOLLERS POINT MULTIPURPOSE CENTER  
323 SOLLERS POINT RD.  
DUNDALK, MD 21222  
COUNCILMATIC DISTRICT: 7  
CONGRESSIONAL DISTRICT: 2  
LEGISLATIVE DISTRICT: 6  
ELECTION DIST. NO.: 12c7



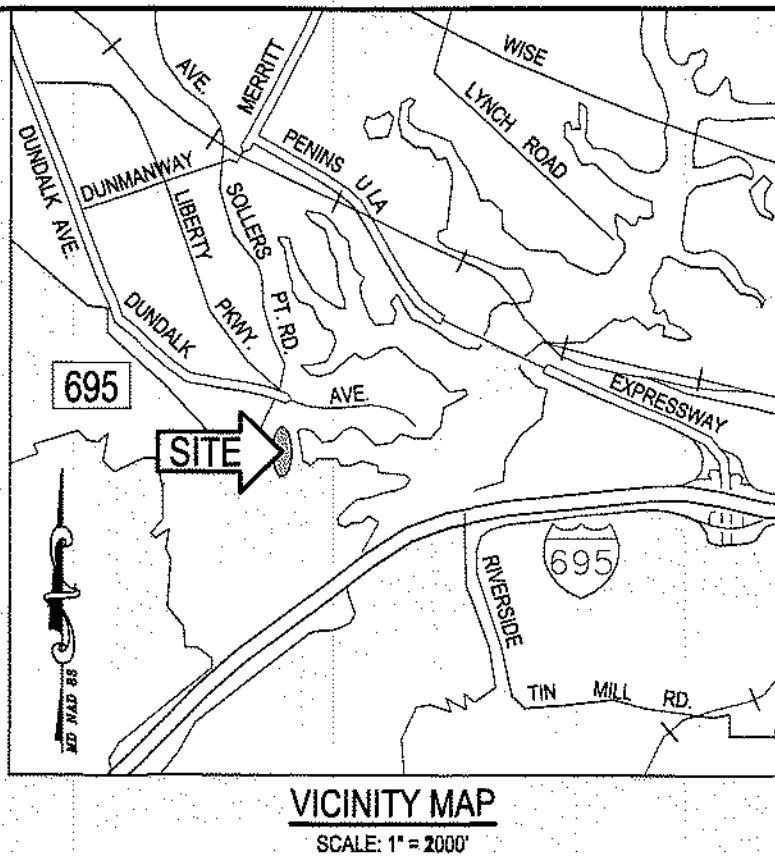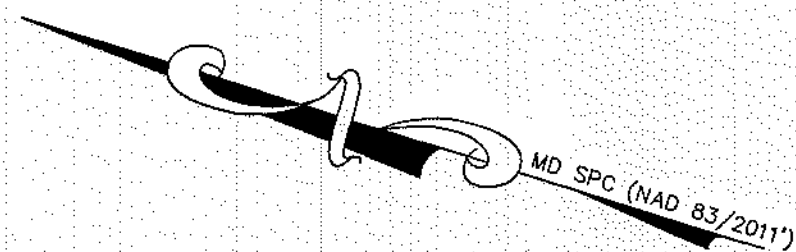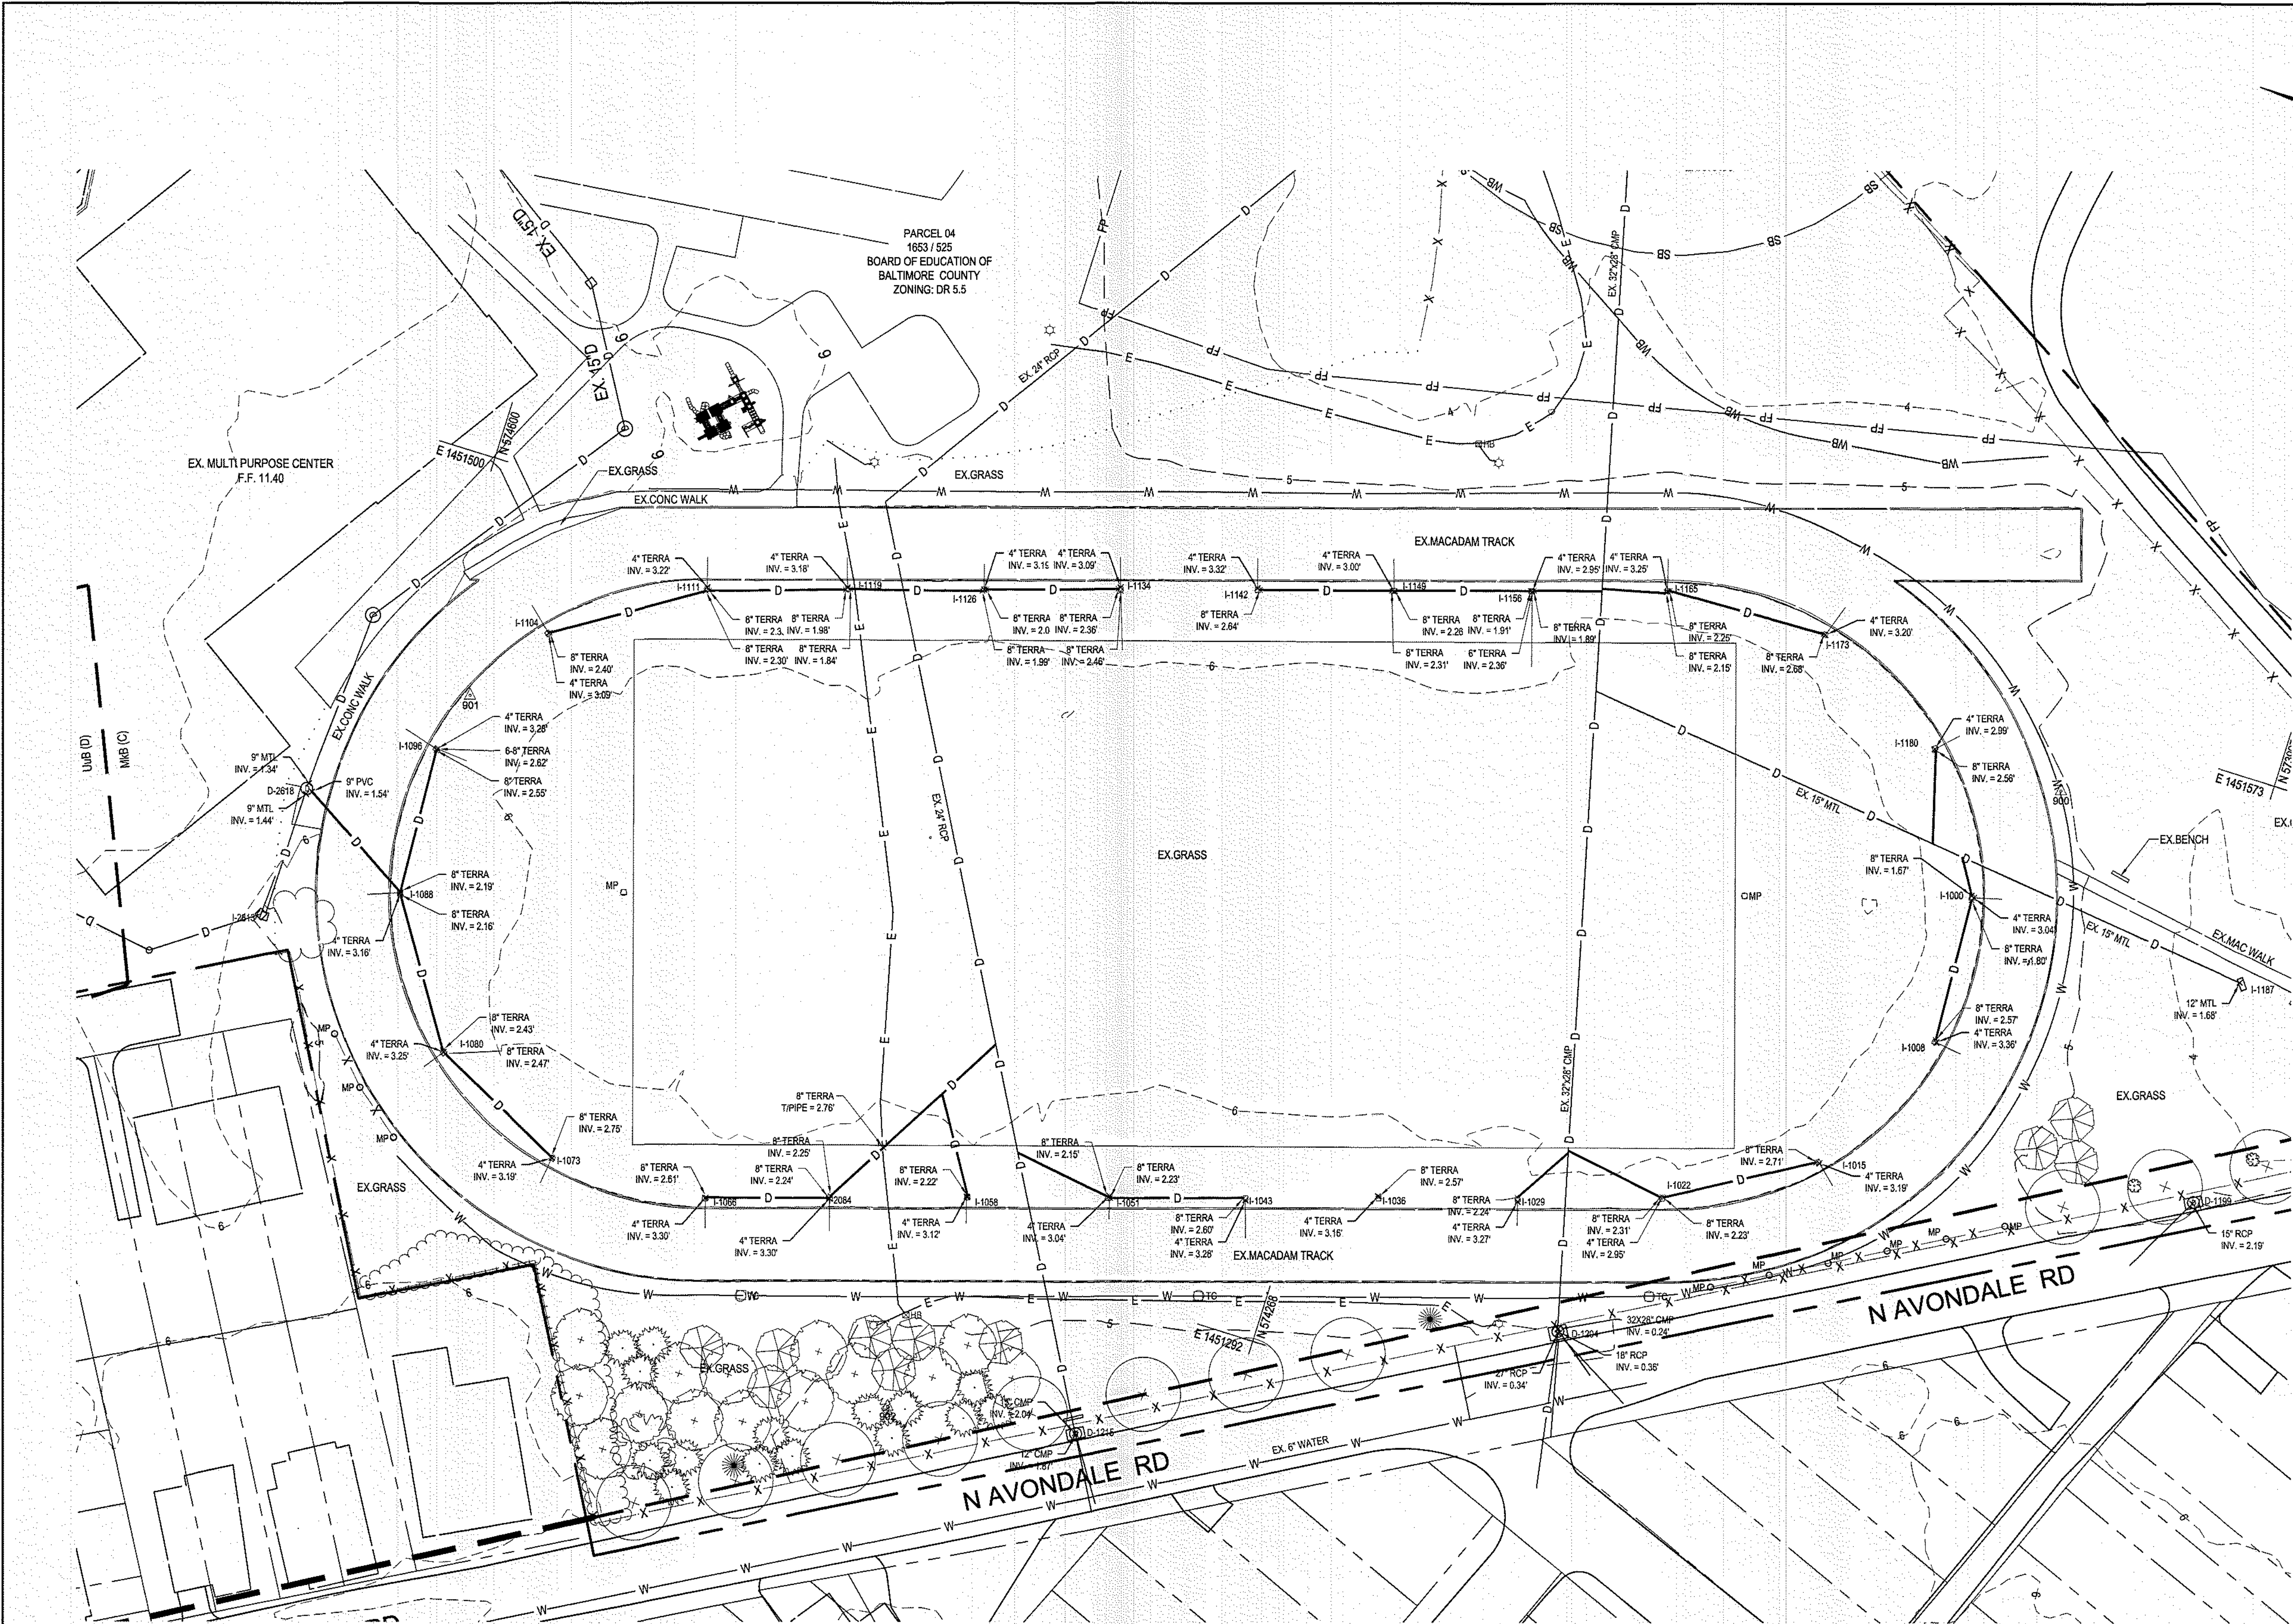


LEGEND	
DESCRIPTION	EXISTING NEW
BUILDING	EX BLDG
BITUMINOUS CONCRETE PAVING	EX. MACADAM
PORTLAND CEMENT CONCRETE	EX. CONC.
CLEAN OUT	⊙
DRAIN INLET	⊙
FIRE HYDRANT	⊙
POWER POLE	⊙
SANITARY MH	⊙
SIGN (ONE-POST)	⊙
STORM DRAIN MH	⊙
STREET LIGHT	⊙
TRAVERSE STATION	⊙
WATER VALVE	⊙
SPOT ELEVATION	⊙
MAJOR CONTOUR	⊙
MINOR CONTOUR	⊙
CONC. CURB	⊙
SURVEY LIMITS	⊙
WOOD FENCE	⊙
GUARDRAIL	⊙
UG ELECTRIC	⊙
UG STORM	⊙
UG WATER	⊙
UG TELEPHONE	⊙
UG IRRIGATION	⊙

SURVEY TRAVERSE CONTROL LISTING			
PTS	NORTHING	EASTING	ELEV. DESCRIPTION
900	574,064.44	1,451,549.92	5.15 REBAR & CAP
901	574,583.72	1,451,420.83	5.79 REBAR & CAP
902	574,378.35	1,451,234.22	4.79 REBAR & CAP

**OWNER**  
PROPERTY MANAGEMENT, CAPITAL SERVICES  
12200 LONG GREEN PIKE  
GLEN ARM, MD 21057  
BRIAN MCKINLEY  
410-887-2915  
SITE ADDRESS:  
323 SOLLERS POINT RD, DUNDALK, MD 21222  
COORDINATES SHOWN HEREON ARE REFERRED TO THE MARYLAND  
STATE PLANE COORDINATE SYSTEM, NAD 83 (1991).  
ELEVATIONS SHOWN HEREON ARE REFERRED TO THE NORTH AMERICAN  
VERTICAL DATUM OF 1988 (NAVD 88).

CONTRACT COMPLETION BOX	
CONTRACTOR:	
DATE COMPLETED:	
INSPECTOR:	
PIPE MATERIAL (Pressure Only):	

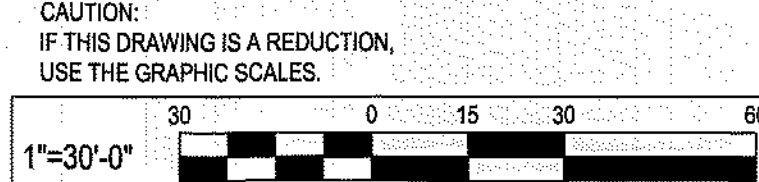

DATE: 9/1/21  
P:\2020\20204101\Drawings\07-Site\20204101-C100-Existing Conditions Plan.dwg

PROFESSIONAL CERTIFICATION		AS-BUILT / REVISION	BY	DATE	P.W.A. NO.	KEY SHEET	POSITION SH	DRAWING SCALE	DEPARTMENT OF PUBLIC WORKS
I HEREBY CERTIFY THAT THESE DOCUMENTS WERE PREPARED OR APPROVED BY ME, AND THAT I AM A FULLY LICENSED PROFESSIONAL ENGINEER UNDER THE LAWS OF THE STATE OF MARYLAND.									
LICENSE NO. 34682 EXPIRATION DATE 07/08/23									
ENGINEER: BLAINE LINKOUS									
DGN BY: K.H.									
DWN BY: H.H.									
CHKD BY: B.L.									
BUREAU OF ENGINEERING AND CONSTRUCTION									
TRAFFIC									
HIGHWAYS									
STRUCTURES									
STORM DRAINS									
SEWER									
WATER									
FIELD ENGINEER									
APPROVED BY:									
DATE:									
APPROVED BY:									
DATE:									



SIGNATURE OF OWNER/DEVELOPER: *[Signature]* TITLE: FACILITIES CHIEF DATE: 8/31/2021

BALTIMORE COUNTY OFFICE OF BUDGET AND FINANCE, PROPERTY MANAGEMENT  
FIELD, TRACK, AND DRAINAGE REPLACEMENT  
**EXISTING CONDITIONS PLAN**  
SOLLERS POINT MULTIPURPOSE CENTER  
323 SOLLERS POINT RD.  
DUNDALK, MD 21222

COUNCILMATIC DISTRICT: 7  
CONGRESSIONAL DISTRICT: 2  
LEGISLATIVE DISTRICT: 6  
ELECTION DIST. NO.: 12c7

SHEET DESIGNATION	CONTRACT NUMBER
2021-2870	22005 POO
JOB ORDER NUMBER	
242-212-307-0472	
SHEET 2 OF 15	
DRAWING NUMBER	
C100	
FILE NO.:	



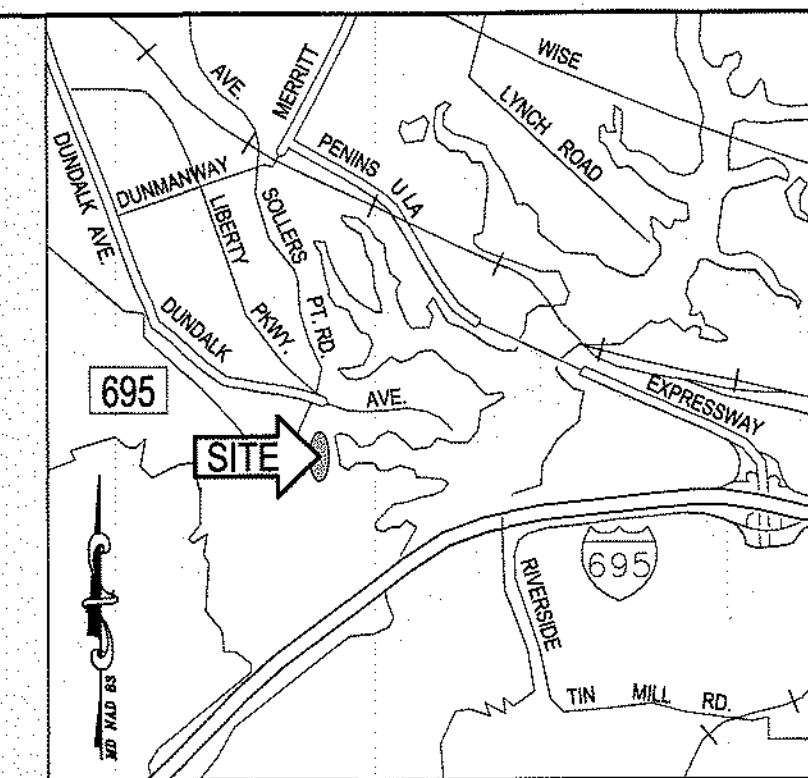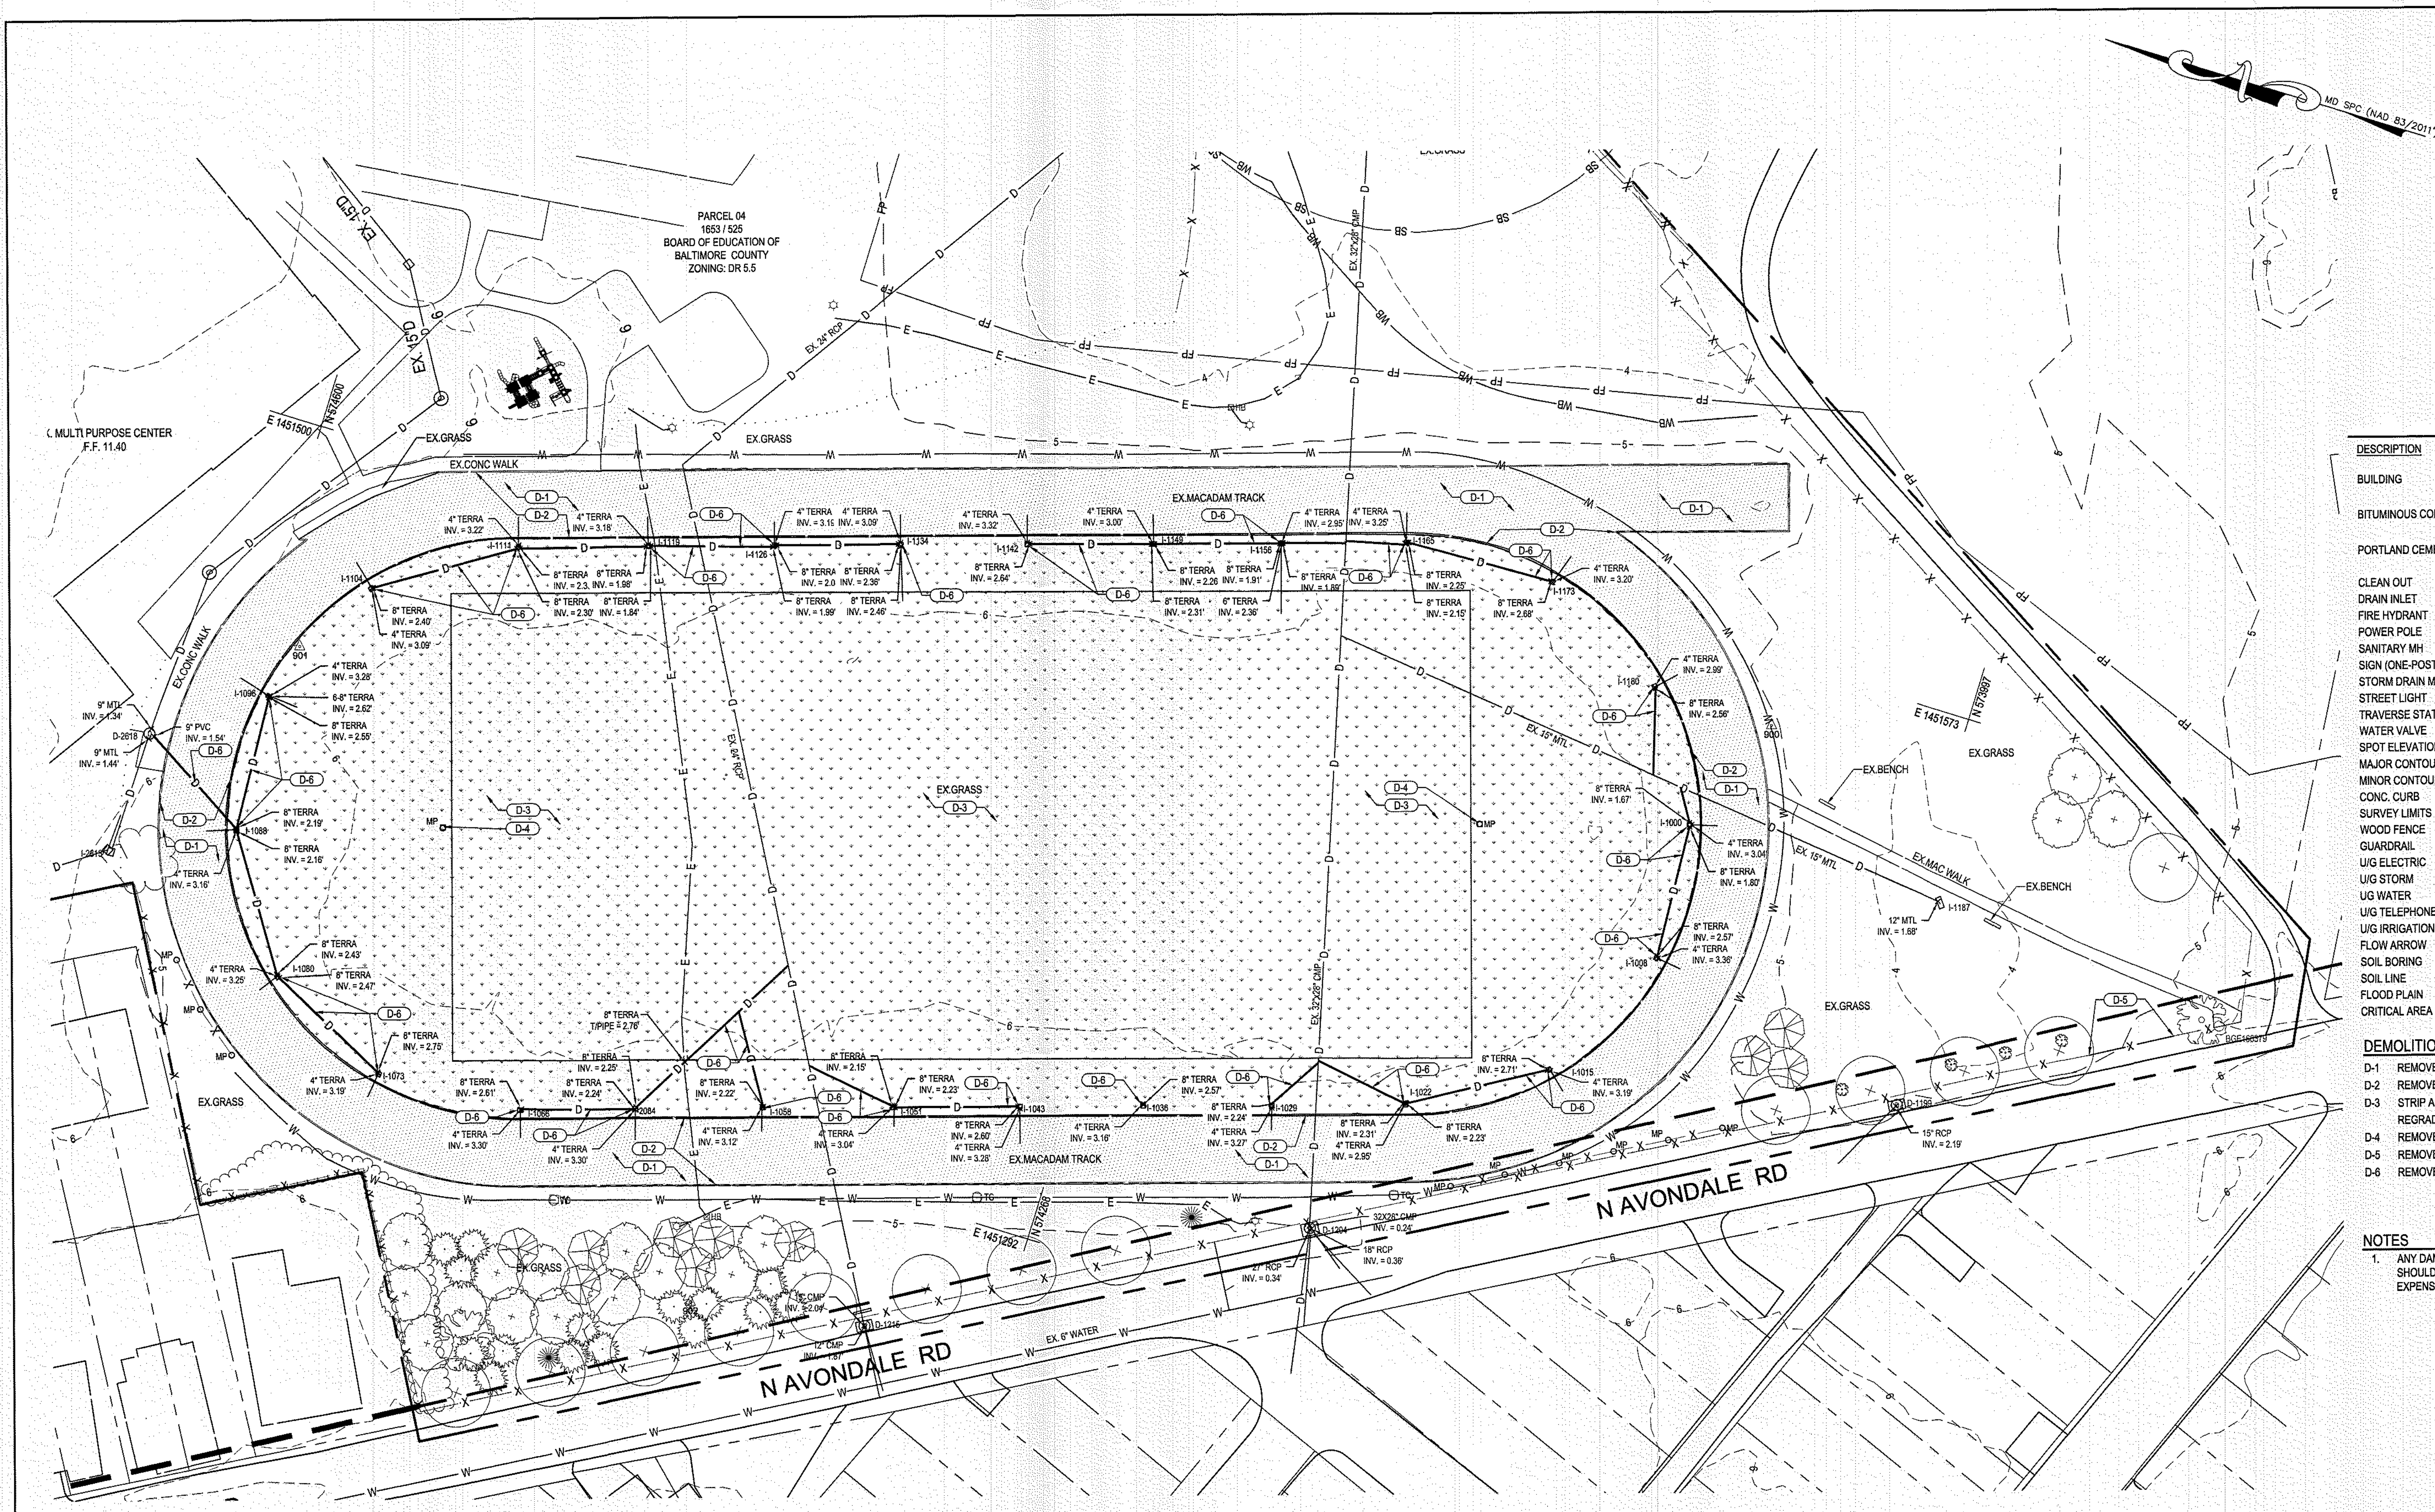

DESCRIPTION	EXISTING	REMOVE
BUILDING	EX. BLDG	
BITUMINOUS CONCRETE PAVING	EX. MACADAM	
PORTLAND CEMENT CONCRETE	EX. CONC.	
CLEAN OUT	⊙	⊙
DRAIN INLET	⊙	⊙
FIRE HYDRANT	⊙	⊙
POWER POLE	⊙	⊙
SANITARY MH	⊙	⊙
SIGN (ONE-POST)	⊙	⊙
STORM DRAIN MH	⊙	⊙
STREET LIGHT	⊙	⊙
TRAVERSE STATION	⊙	⊙
WATER VALVE	⊙	⊙
SPOT ELEVATION	⊙	⊙
MAJOR CONTOUR	⊙	⊙
MINOR CONTOUR	⊙	⊙
CONC. CURB	⊙	⊙
SURVEY LIMITS	⊙	⊙
WOOD FENCE	⊙	⊙
GUARDRAIL	⊙	⊙
U/G ELECTRIC	⊙	⊙
U/G STORM	⊙	⊙
U/G WATER	⊙	⊙
U/G TELEPHONE	⊙	⊙
U/G IRRIGATION	⊙	⊙
FLOW ARROW	⊙	⊙
SOIL BORING	⊙	⊙
SOIL LINE	⊙	⊙
FLOOD PLAIN	⊙	⊙
CRITICAL AREA BUFFER	⊙	⊙

- DEMOLITION**
- D-1 REMOVE BITUMINOUS CONCRETE PAVING (TRACK).
  - D-2 REMOVE CONCRETE CURB AND GUTTER.
  - D-3 STRIP AND STOCKPILE EXISTING GRASS/TOPSOIL TO THE EXTENTS NECESSARY TO REGRADE FIELD.
  - D-4 REMOVE AND STORE EXISTING GOAL POSTS.
  - D-5 REMOVE AND SALVAGE EXISTING FENCE AND POSTS.
  - D-6 REMOVE EXISTING STORM DRAIN STRUCTURES AND CONNECTING PIPES.

**NOTES**

1. ANY DAMAGE TO EXISTING FEATURES NOT INCLUDED IN THIS SCOPE OF WORK SHOULD BE RETURNED TO ITS ORIGINAL CONDITION AT THE CONTRACTORS EXPENSE.


**OWNER**  
PROPERTY MANAGEMENT, CAPITAL SERVICES  
12200 LONG GREEN PIKE  
GLEN ARM, MD 21057  
BRIAN MCKINLEY  
410-887-2915  
SITE ADDRESS:  
323 SOLLERS POINT RD, DUNDALK, MD 21222  
COORDINATES SHOWN HEREON ARE REFERRED TO THE MARYLAND  
STATE PLANS COORDINATE SYSTEM, NAD 83 (1981)  
ELEVATIONS SHOWN HEREON ARE REFERRED TO THE NORTH AMERICAN  
VERTICAL DATUM OF 1988 (NAVD 88).

CONTRACT COMPLETION BOX	
CONTRACTOR:	
DATE COMPLETED:	
INSPECTOR:	
PIPE MATERIAL (Pressure Only):	

SHEET DESIGNATION	CONTRACT NUMBER
2021-2871	22005 P00
JOB ORDER NUMBER 242-212-307-0472	
SHEET 3 OF 15 DRAWING NUMBER C101	
FILE NO.:	

PLAN VIEW  
SCALE: 1" = 30'



*AM Loan* FACILITIES CHIEF 8/31/2021  
SIGNATURE OF OWNER/DEVELOPER TITLE DATE

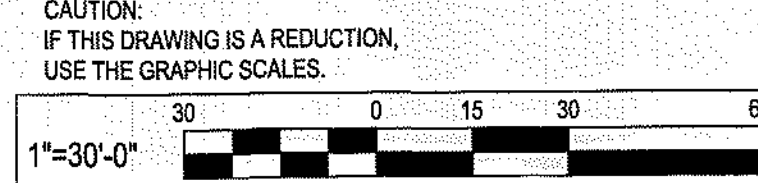

SEAL	PROFESSIONAL CERTIFICATION	AS-BUILT / REVISION	BY	DATE	P.W.A. NO.	KEY SHEET	POSITION SH	DRAWING SCALE	DEPARTMENT OF PUBLIC WORKS		
	I HEREBY CERTIFY THAT THESE DOCUMENTS WERE PREPARED OR APPROVED BY ME, AND THAT I AM A DULY LICENSED PROFESSIONAL ENGINEER UNDER THE LAWS OF THE STATE OF MARYLAND. LICENSE NO. 34682 EXPIRATION DATE 07/08/23 ENGINEER: BLAINE LINKOUS BUREAU OF ENGINEERING AND CONSTRUCTION WBCM DESIGNING INFRASTRUCTURE FOR TOMORROW										
		CONTRACT COMPLETION BOX	BUREAU OF ENGINEERING AND CONSTRUCTION	TRAFFIC	HIGHWAYS	STRUCTURES	STORM DRAINS	SEWER	WATER	FIELD ENGINEER	BUR. OF ENGINEERING & CONSTRUCTION
		DGN BY: K.H.	REVIEWED BY:								APPROVED BY: CHIEF
		DWN BY: H.H.									DATE:
		CHKD BY: B.L.	DATE REVIEWED:								

BALTIMORE COUNTY OFFICE OF BUDGET AND FINANCE, PROPERTY MANAGEMENT  
FIELD, TRACK, AND DRAINAGE REPLACEMENT  
**DEMOLITION PLAN**  
SOLLERS POINT MULTIPURPOSE CENTER  
323 SOLLERS POINT RD.  
DUNDALK, MD 21222  
SUBDIVISION: SOLLERS POINT  
COUNCILMATIC DISTRICT: 7  
CONGRESSIONAL DISTRICT: 2  
LEGISLATIVE DISTRICT: 6  
ELECTION DIST. NO.: 12c7



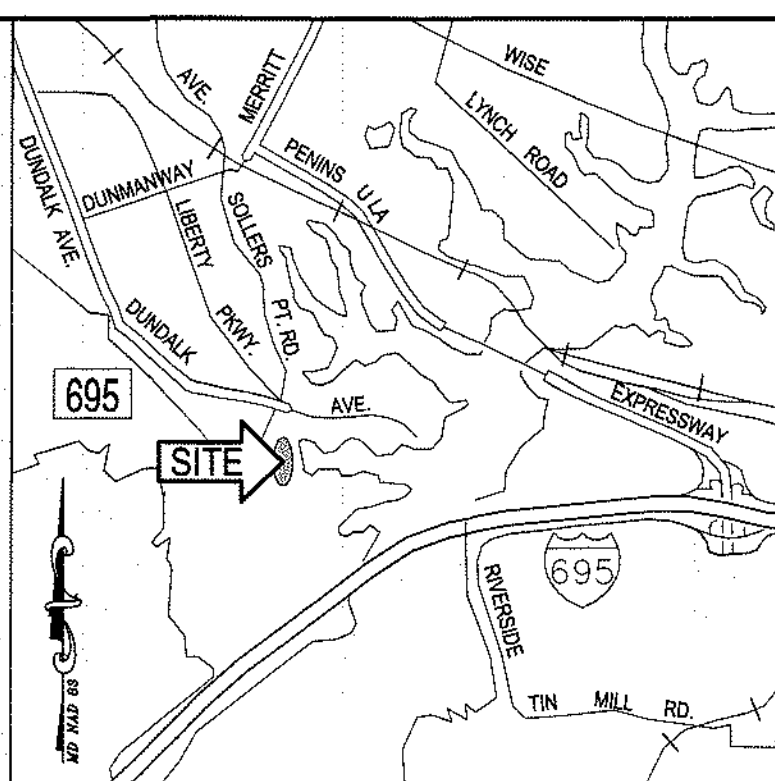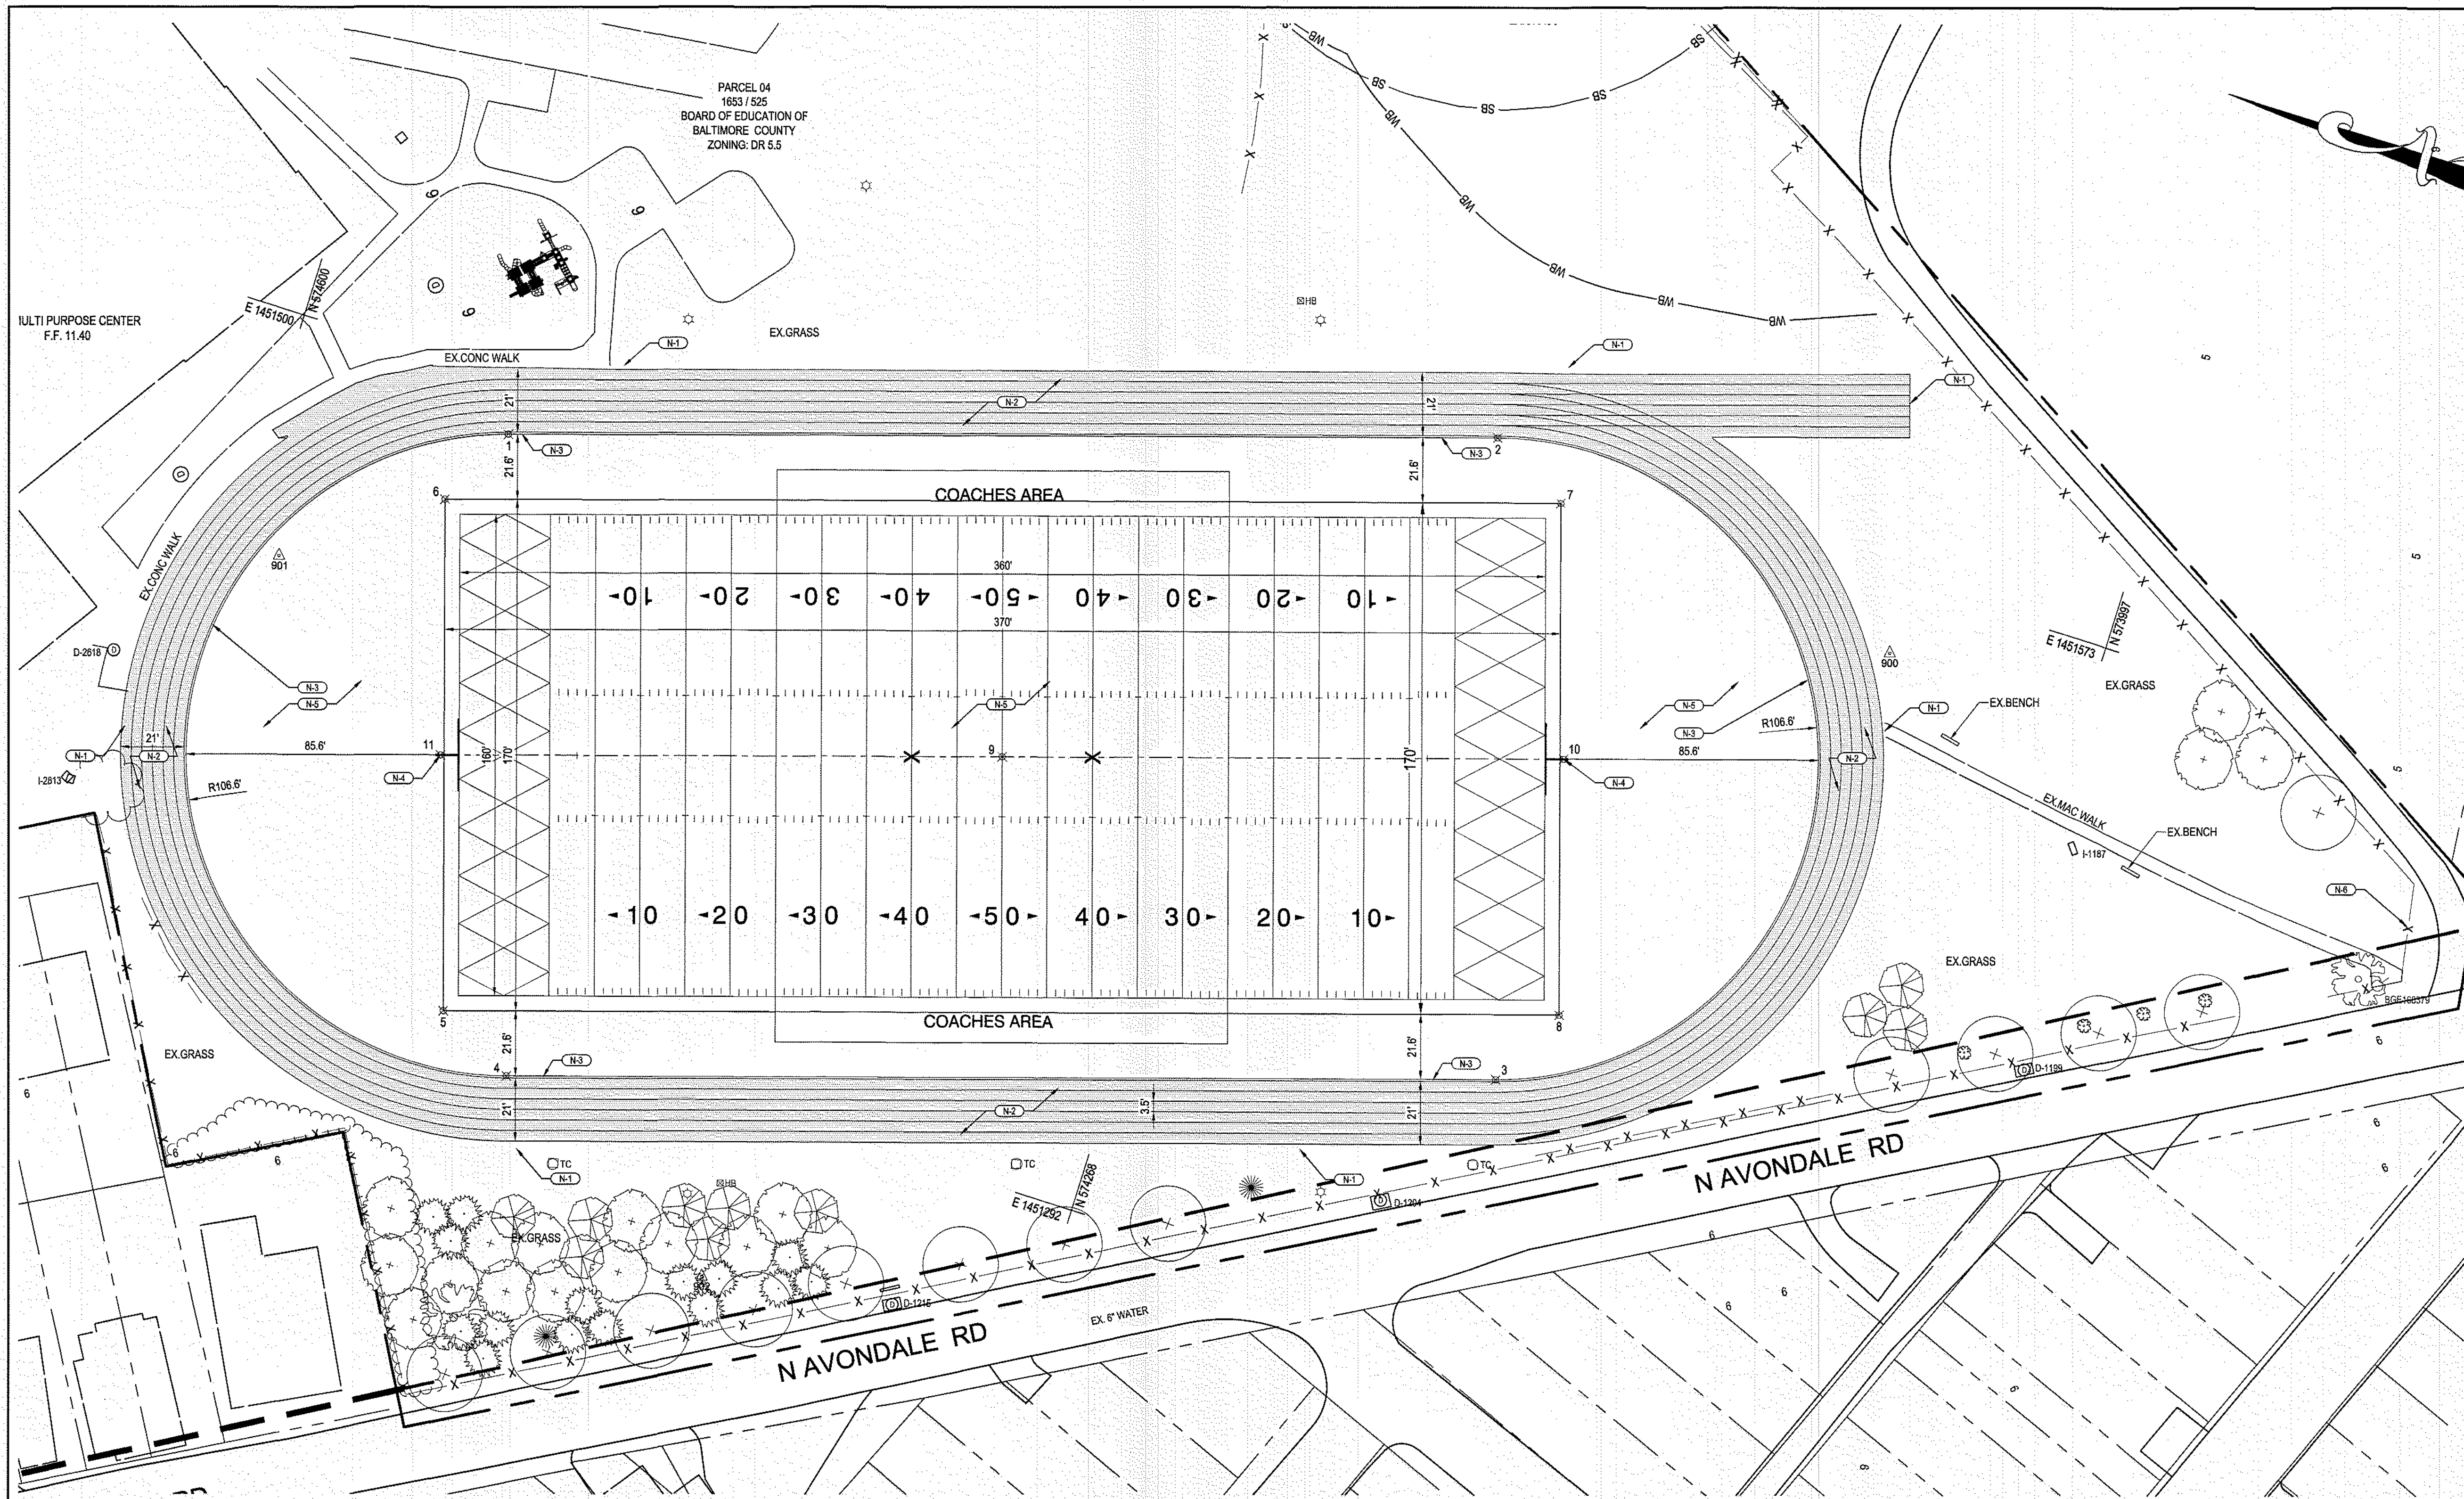


DESCRIPTION	EXISTING	NEW
BUILDING	EX. BLDG	
BITUMINOUS CONCRETE PAVING	EX. MACADAM	
PORTLAND CEMENT CONCRETE	EX. CONC.	
CLEAN OUT		
DRAIN INLET		
FIRE HYDRANT		
POWER POLE		
SANITARY MH		
SIGN (ONE-POST)		
STORM DRAIN MH		
STREET LIGHT		
TRAVERSE STATION		
WATER VALVE		
SPOT ELEVATION		
MAJOR CONTOUR		
MINOR CONTOUR		
CONC. CURB		
SURVEY LIMITS		
WOOD FENCE		
GUARDRAIL		
UG ELECTRIC		
UG STORM		
UG WATER		
UG TELEPHONE		
UG IRRIGATION		
FLOW ARROW		
SOIL BORING		
SOIL LINE		
FLOOD PLAIN		
CRITICAL AREA BUFFER		

GEOMETRY POINT TABLE			
PT #	DESCRIPTION	NORTHING	EASTING
1	PT CONCRETE CURB	574523.17	1451482.11
2	PC CONCRETE CURB	574209.77	1451579.15
3	PT CONCRETE CURB	574146.71	1451575.49
4	PC CONCRETE CURB	574460.11	1451276.44
5	CORNER FIELD	574466.52	1451292.88
6	CORNER FIELD	574536.80	1451455.27
7	CORNER FIELD	574183.36	1451564.72
8	CORNER FIELD	574133.08	1451402.32
9	CENTER FIELD	574334.94	1451428.80
10	CENTER GOAL POST	574157.05	1451483.92
11	CENTER GOAL POST	574512.83	1451373.70

**OWNER**  
PROPERTY MANAGEMENT, CAPITAL SERVICES  
12200 LONG GREEN PIKE  
GLEN ARM, MD 21057  
BRIAN MCKINLEY  
410-687-2915  
SITE ADDRESS:  
323 SOLLERS POINT RD, DUNDALK, MD 21222  
COORDINATES SHOWN HEREON ARE REFERRED TO THE MARYLAND  
STATE PLANE COORDINATE SYSTEM, NAD 83 (1991).  
ELEVATIONS SHOWN HEREON ARE REFERRED TO THE NORTH AMERICAN  
VERTICAL DATUM OF 1988 (NAVD 88).

CONTRACT COMPLETION BOX	
CONTRACTOR:	
DATE COMPLETED:	
INSPECTOR:	
PIPE MATERIAL (Pressure Only):	

- CONSTRUCTION NOTES**
- N-1 MEET EXISTING CONDITIONS.
  - N-2 NEW BITUMINOUS TRACK, SEE DETAIL 1 ON SHEET C201.
  - N-3 NEW CONCRETE CURB, SEE DETAIL 2 ON SHEET C201.
  - N-4 INSTALL GOAL POST AND FOUNDATION, SEE DETAIL 3 ON SHEET C201.
  - N-5 NEW NATURAL GRASS FIELD.

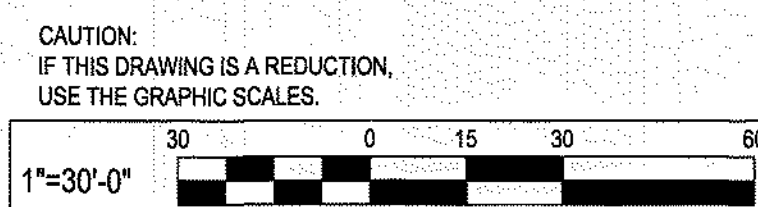


PROFESSIONAL CERTIFICATION		AS-BUILT / REVISION	BY	DATE	P.W.A. NO.	KEY SHEET	POSITION	SHT	DRAWING SCALE	DEPARTMENT OF PUBLIC WORKS
I HEREBY CERTIFY THAT THESE DOCUMENTS WERE PREPARED OR APPROVED BY ME AND THAT I AM A DULY LICENSED PROFESSIONAL ENGINEER UNDER THE LAWS OF THE STATE OF MARYLAND.										
LICENSE NO. 34682 EXPIRATION DATE 07/08/23										
ENGINEER: BLAINE LINKOUS		CONTRACT COMPLETION BOX								
DON BY: K.H.		BUREAU OF ENGINEERING AND CONSTRUCTION								
DWN BY: H.H.		TRAFFIC								
CHD BY: B.L.		REVIEWED BY:								
		DATE REVIEWED:								

SIGNATURE OF OWNER/DEVELOPER: *[Signature]* TITLE: FACILITIES CHIEF DATE: 8/31/2021

BALTIMORE COUNTY OFFICE OF BUDGET AND FINANCE, PROPERTY MANAGEMENT  
FIELD, TRACK, AND DRAINAGE REPLACEMENT  
**SITE LAYOUT PLAN**  
SOLLERS POINT MULTIPURPOSE CENTER  
323 SOLLERS POINT RD.  
DUNDALK, MD 21222



COUNCILMATIC DISTRICT: 7  
CONGRESSIONAL DISTRICT: 2  
LEGISLATIVE DISTRICT: 6  
ELECTION DIST. NO.: 12c7

SHEET DESIGNATION	CONTRACT NUMBER
2021-2872	22005 P00
JOB ORDER NUMBER 242-212-307-0472	
SHEET 4 OF 15 DRAWING NUMBER <b>C200</b>	
FILE NO.: 2021-2872-04	

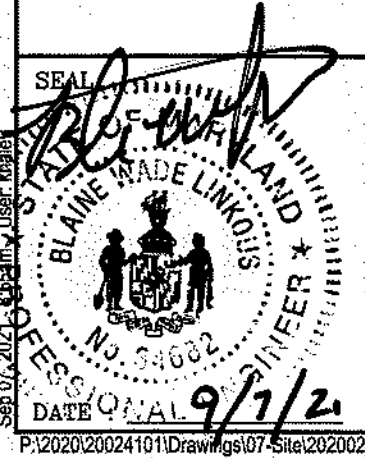




5 MM WEARING COURSE - 1-2 MM EMBEDDED EPDM GRANULES  
8 MM RESILIENT LAYER (SEE SPECIFICATIONS)

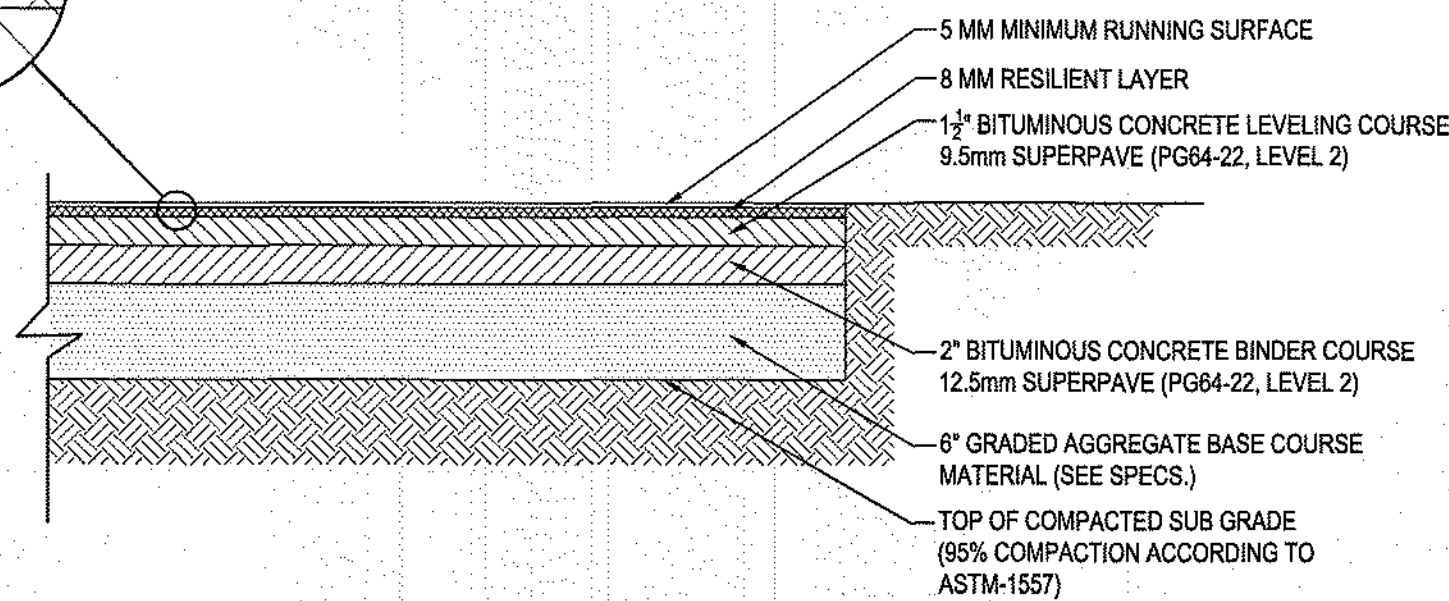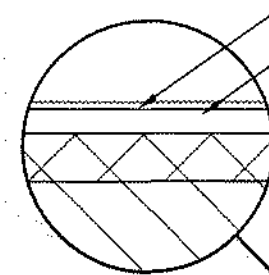


SECTION

1 TRACK PAVING SECTION  
C201 NOT TO SCALE

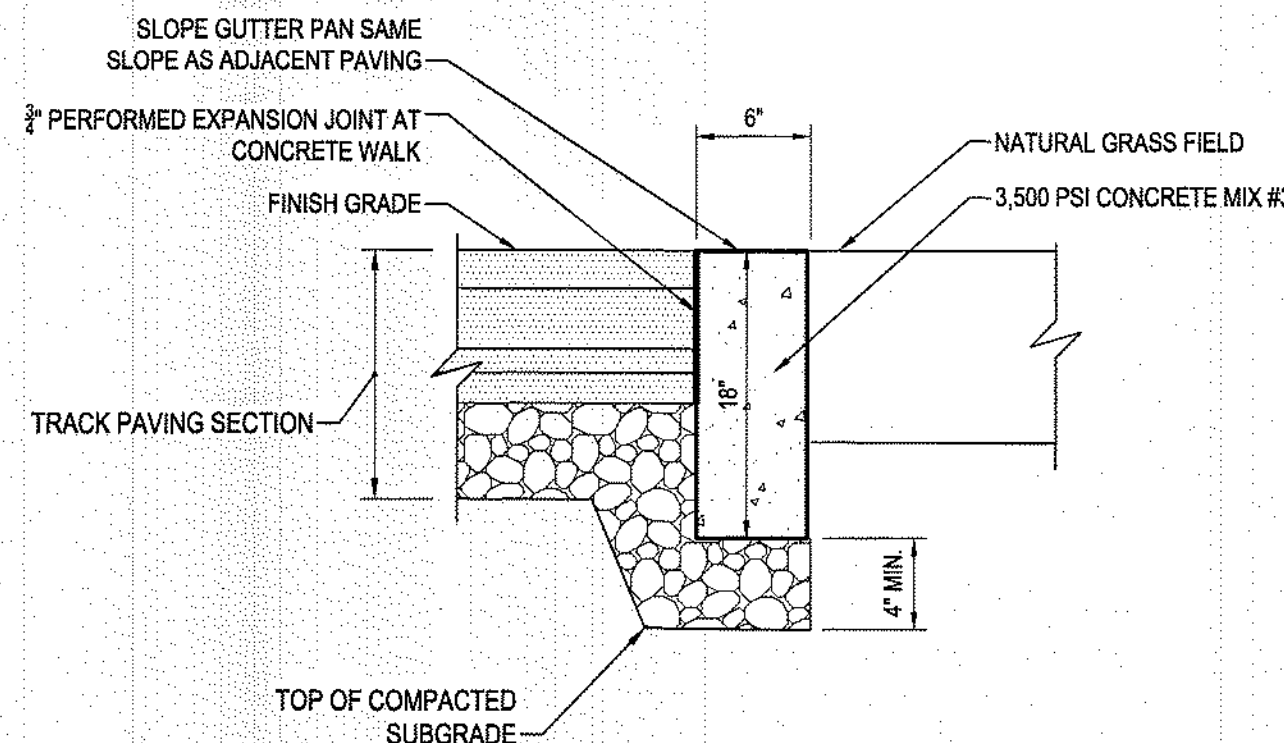

SECTION


2 CONCRETE FLUSH CURB  
C201 SCALE: 1\"/>

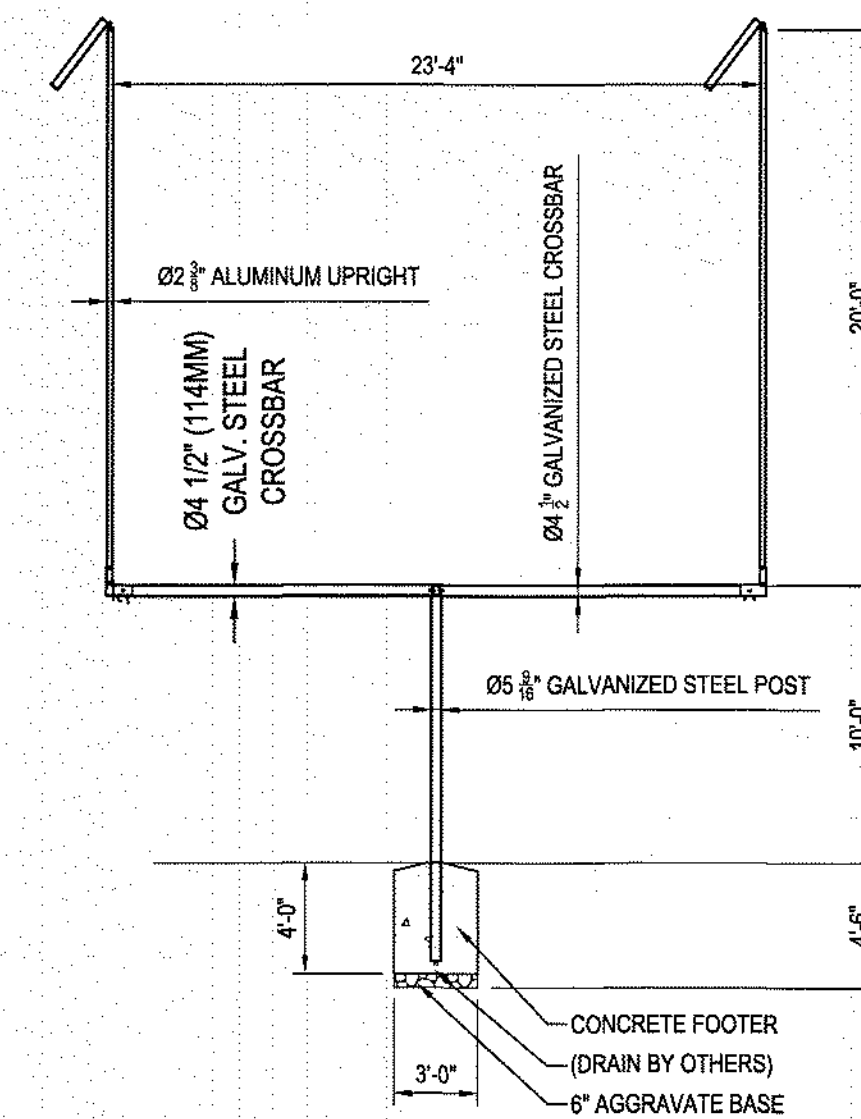

SIDE VIEW


NOTES:

- GOOSENECK AND CROSSBAR ARE GALVANIZED STEEL UPRIGHT ARE HEAVY WALL ALUMINUM TUBING.
- CROSSBAR RETAINS LEVEL BY SET SCREWS & LOCKING BOLT.
- GOOSENECK, CROSSBAR & UPRIGHTS CAN BE FURNISHED IN EITHER WHITE OR YELLOW POWDER COAT FINISH. CUSTOMER TO SPECIFY COLOR AT TIME OF ORDER.
- THREADED ROD INSTALLED IN POST PREVENTS GOAL POST ROTATION IN CONCRETE.

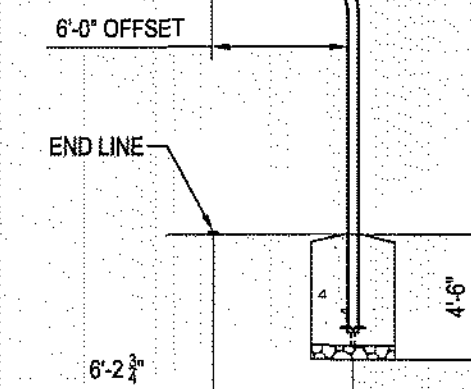



FRONT VIEW

3 GOAL POST AND FOOTER  
C201 NOT TO SCALE

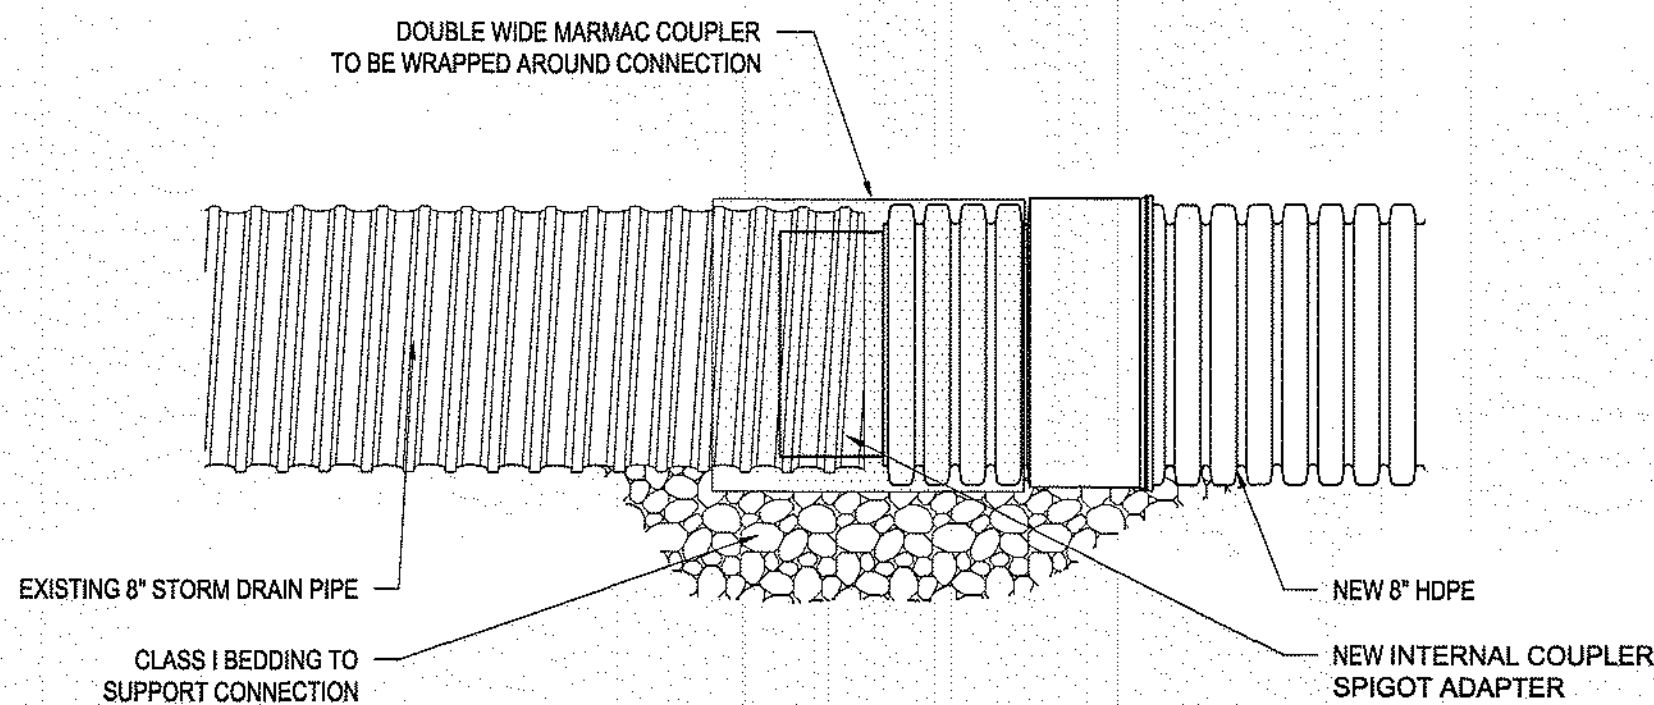

SECTION

4 COUPLER ADAPTER  
C201 NOT TO SCALE

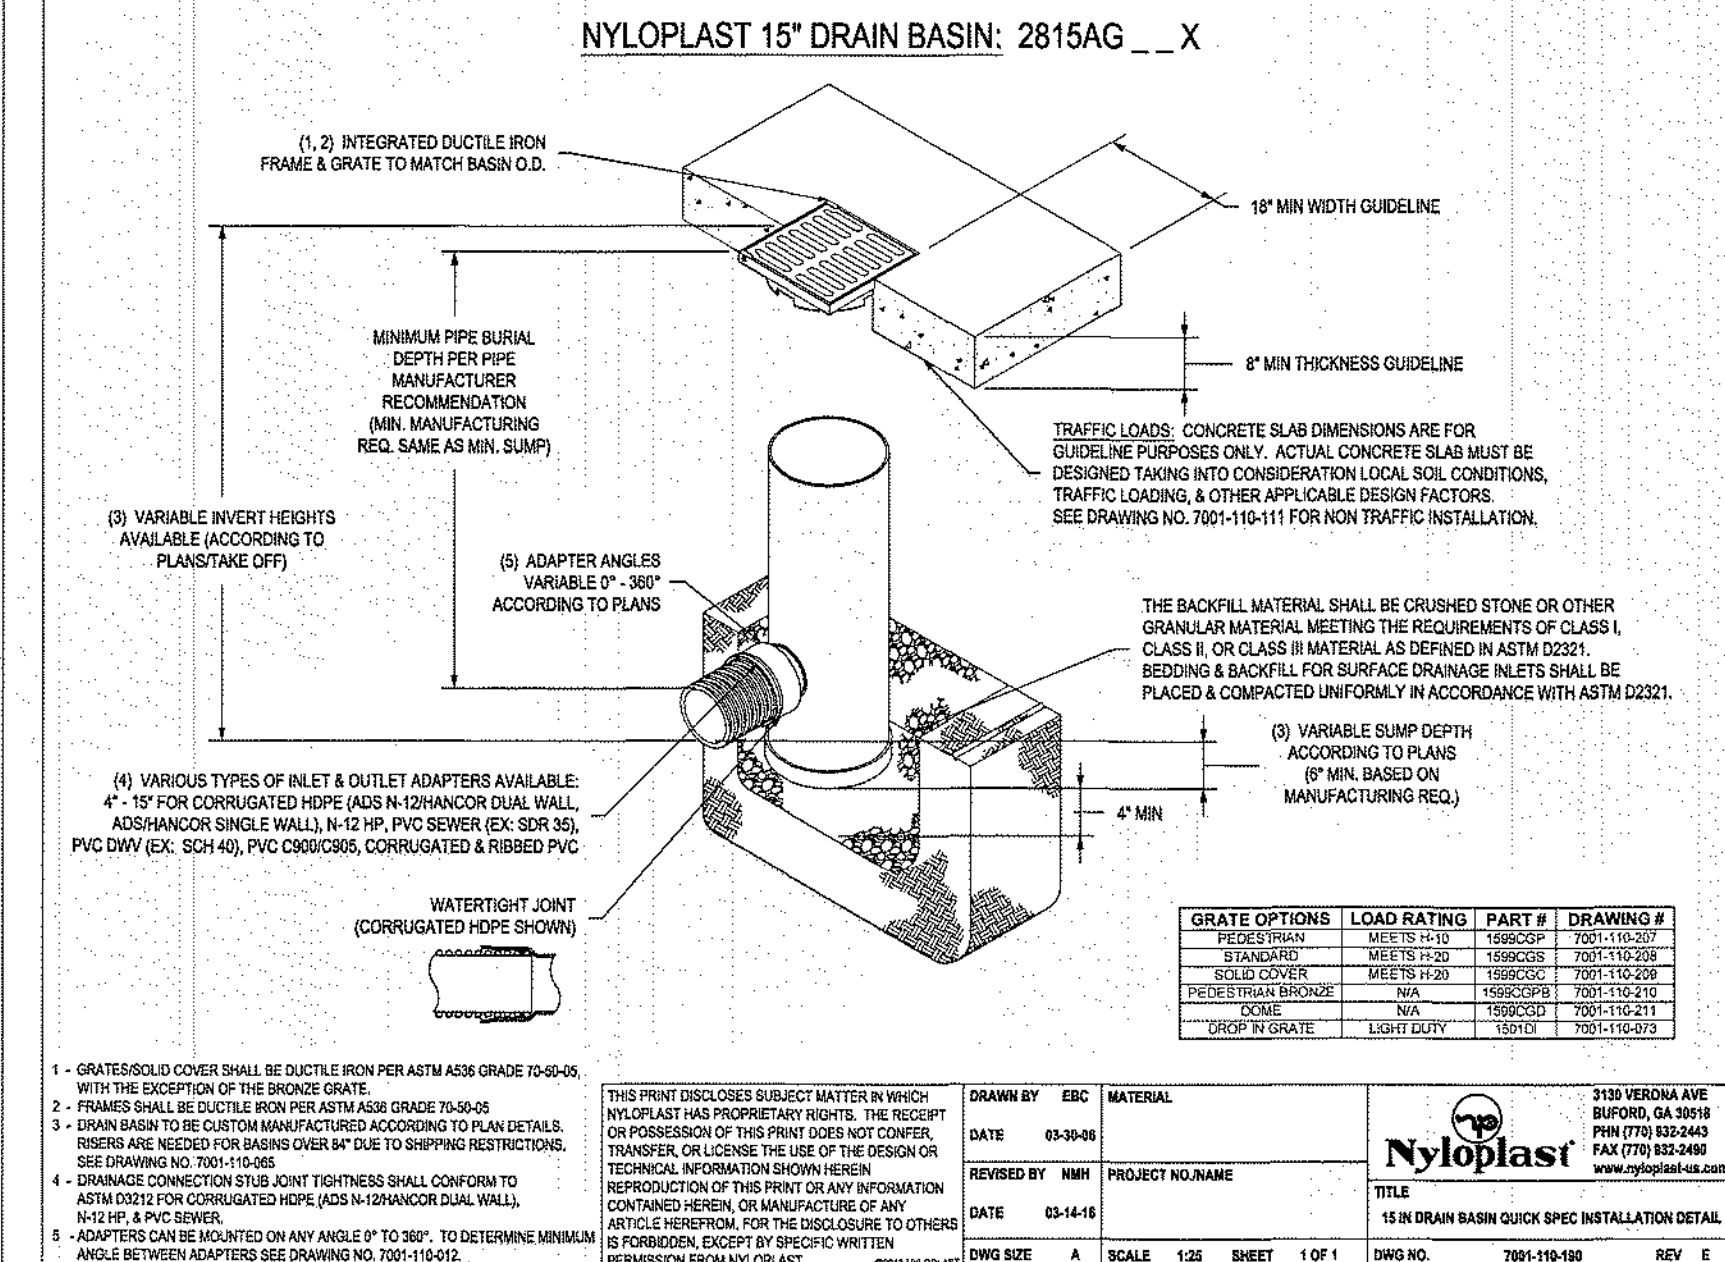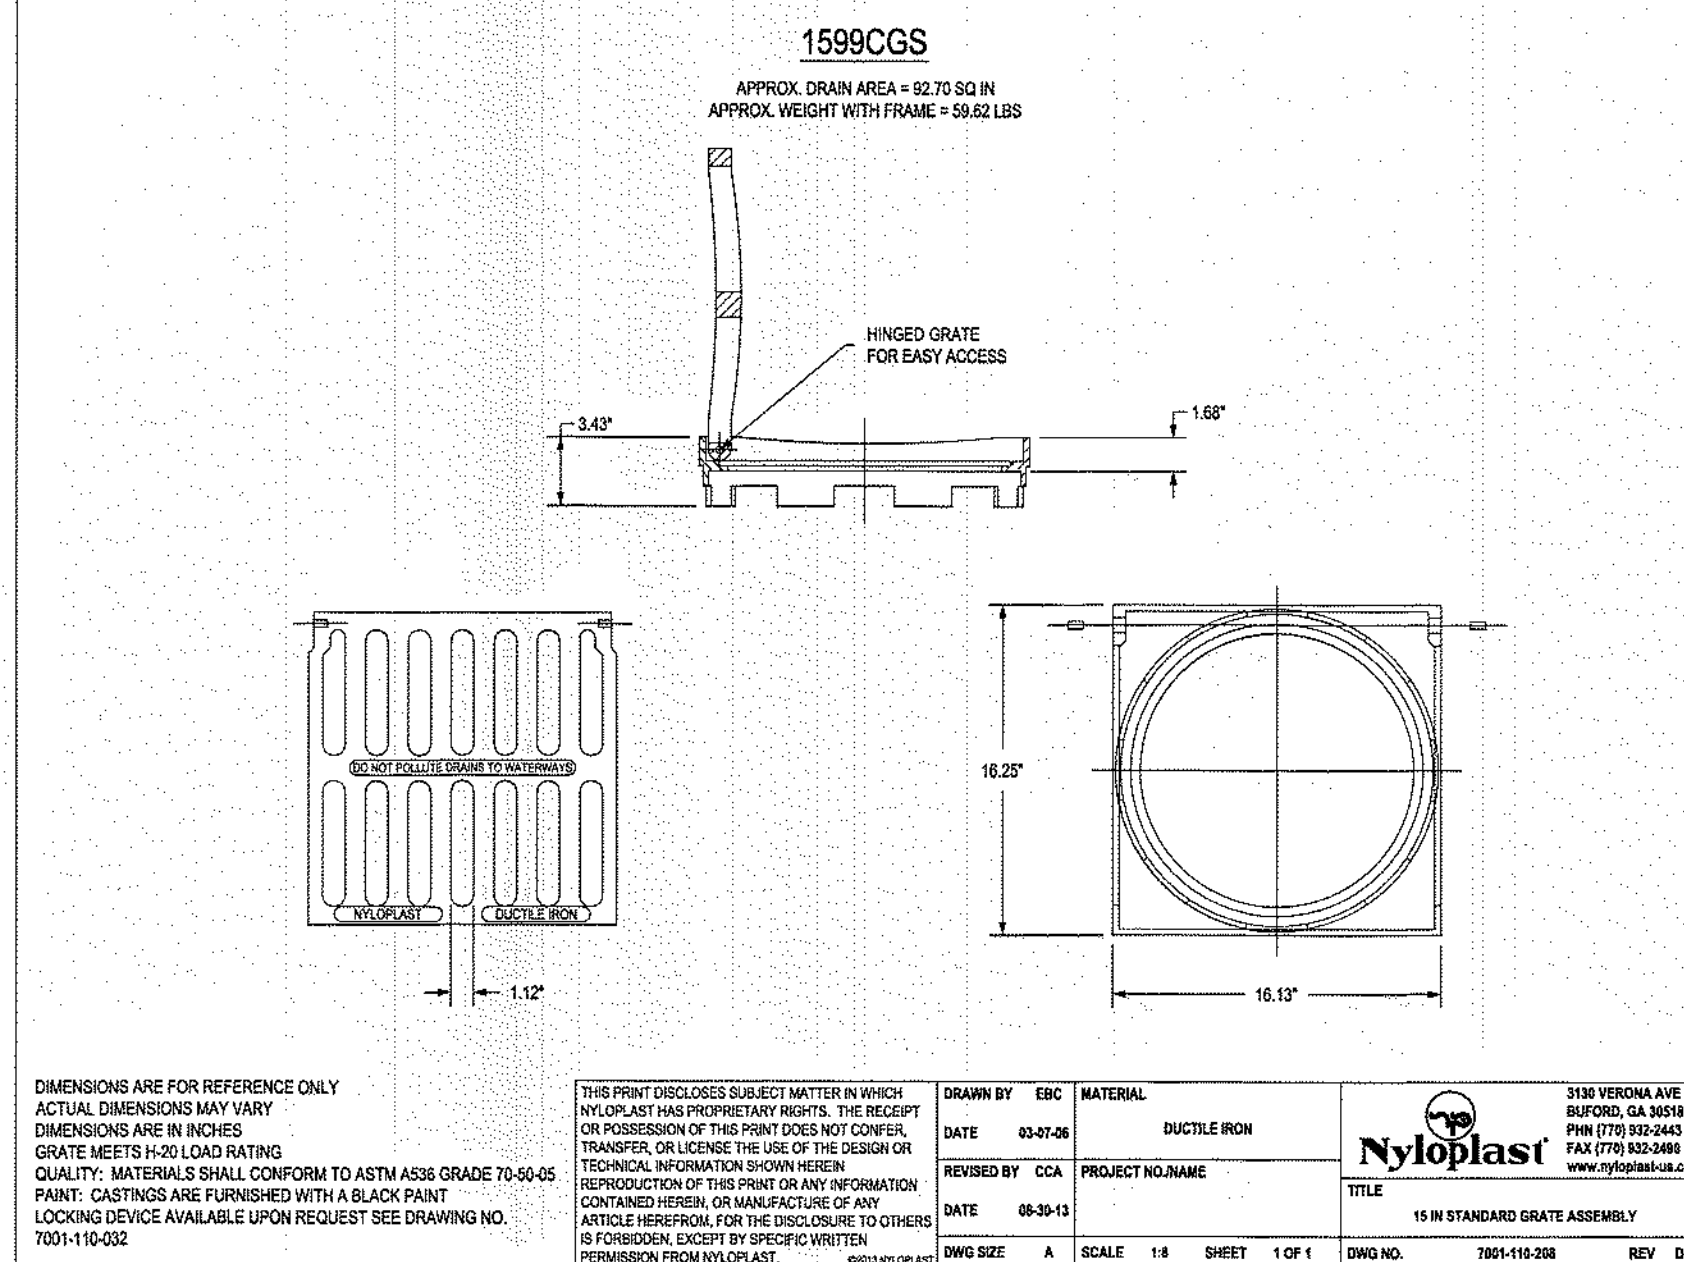

5 NYLOPLAST DRAIN BASIN  
C201 NOT TO SCALE

	PROFESSIONAL CERTIFICATION		AS-BUILT / REVISION	BY	DATE	P.W.A. NO.	KEY SHEET	POSITION	SHT	DRAWING SCALE	DEPARTMENT OF PUBLIC WORKS
	I HEREBY CERTIFY THAT THESE DOCUMENTS WERE PREPARED OR APPROVED BY ME AND THAT I AM A DULY LICENSED PROFESSIONAL ENGINEER UNDER THE LAWS OF THE STATE OF MARYLAND.										
	LICENSE NO. 34682 EXPIRATION DATE 07/09/23										
	ENGINEER: BLAINE LINKOUS		DGN BY: K.H.	BUREAU OF ENGINEERING AND CONSTRUCTION	TRAFFIC	HIGHWAYS	STRUCTURES	STORM DRAINS	SEWER	WATER	FIELD ENGINEER
DATE: 9/7/21		DWN BY: H.H.	REVIEWED BY:								APPROVED BY: CHIEF
CHKD BY: B.L.		DATE REVIEWED:									DATE:

SIGNATURE OF OWNER/DEVELOPER: *[Signature]* TITLE: FACILITIES CHIEF DATE: 8/31/2021


BALTIMORE COUNTY OFFICE OF BUDGET AND FINANCE, PROPERTY MANAGEMENT  
FIELD, TRACK, AND DRAINAGE REPLACEMENT  
SITE DETAILS  
SOLLERS POINT MULTIPURPOSE CENTER  
323 SOLLERS POINT RD.  
DUNDALK, MD 21222

COUNCILMATIC DISTRICT: 7  
CONGRESSIONAL DISTRICT: 2  
LEGISLATIVE DISTRICT: 6  
ELECTION DIST. NO.: 12c7

OWNER  
PROPERTY MANAGEMENT, CAPITAL SERVICES  
12200 LONG GREEN PIKE  
GLEN ARM, MD 21057  
BRIAN MCKINLEY  
410-887-2915  
SITE ADDRESS:  
323 SOLLERS POINT RD, DUNDALK, MD 21222  
COORDINATES SHOWN HEREON ARE REFERRED TO THE MARYLAND STATE PLANE COORDINATE SYSTEM, NAD 83 (1991).  
ELEVATIONS SHOWN HEREON ARE REFERRED TO THE NORTH AMERICAN VERTICAL DATUM OF 1988 (NAVD 88).


CONTRACT COMPLETION BOX	
CONTRACTOR: _____	
DATE COMPLETED: _____	
INSPECTOR: _____	
PIPE MATERIAL (Pressure Only): _____	
SHEET DESIGNATION	CONTRACT NUMBER
2021-2873	22005 POO
JOB ORDER NUMBER	
242-212-307-0472	
SHEET 5 OF 15	
DRAWING NUMBER	
C201	
FILE NO.: _____	



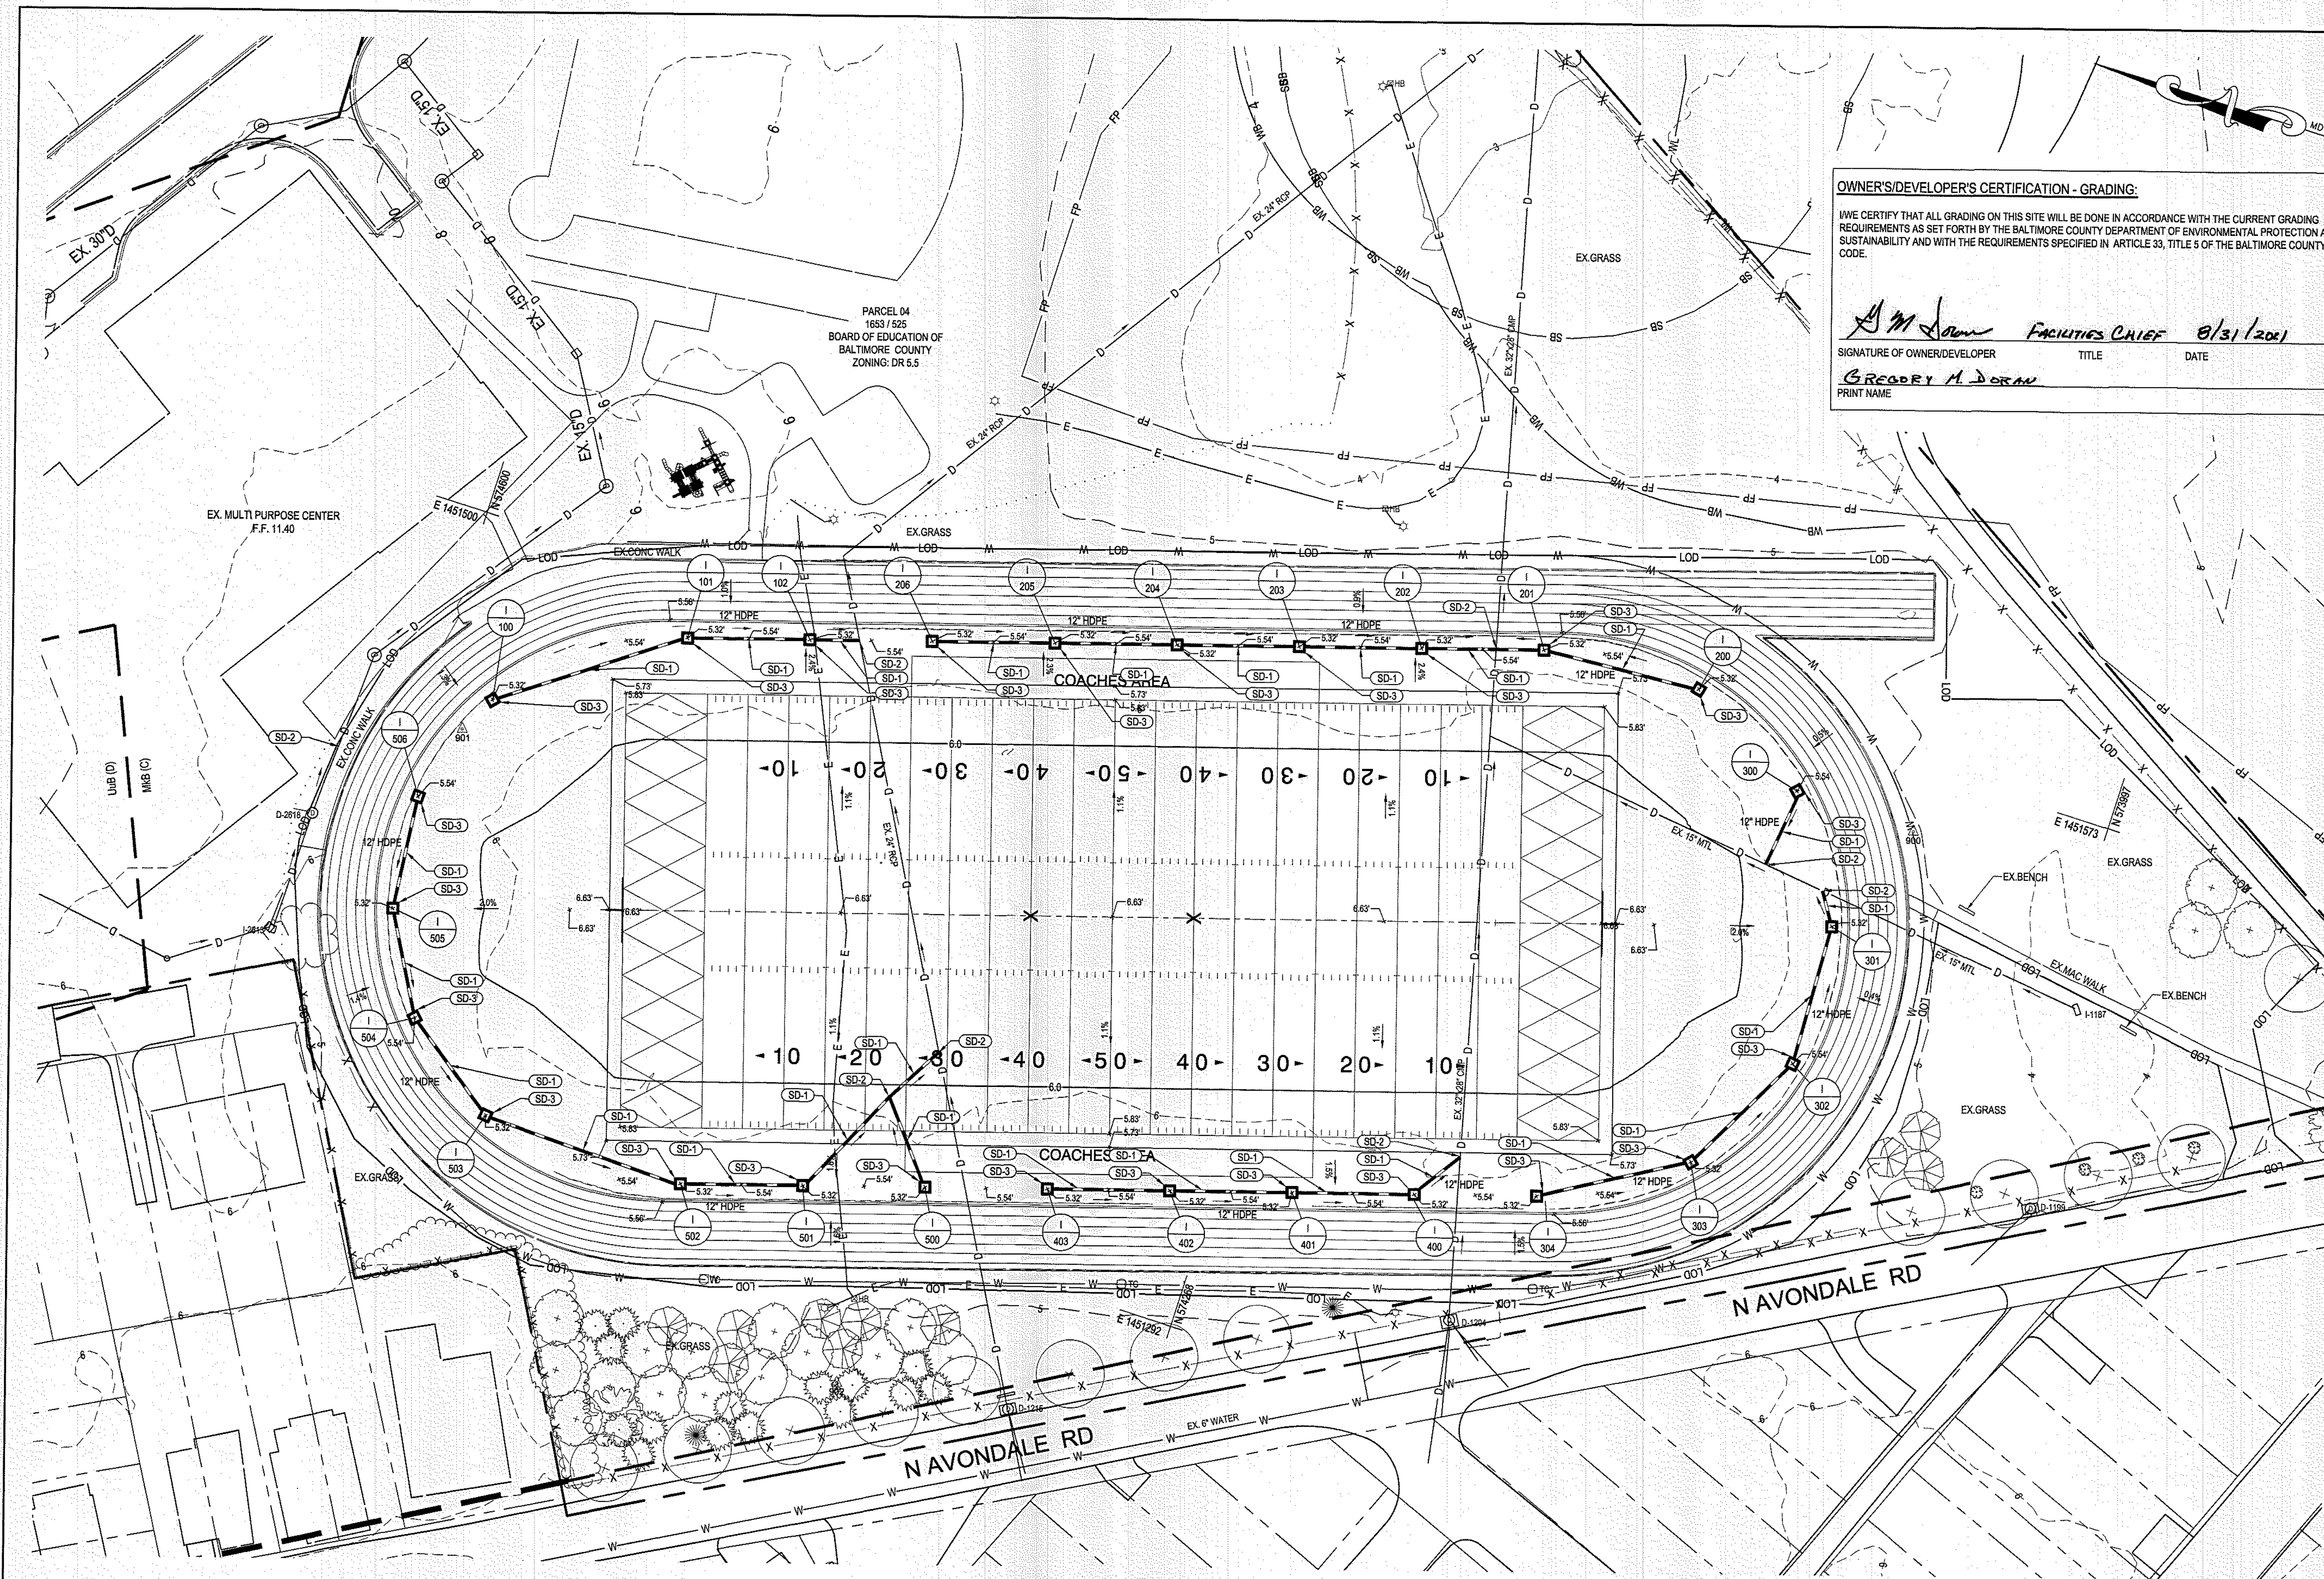

**OWNER'S/DEVELOPER'S CERTIFICATION - GRADING:**  
I/WE CERTIFY THAT ALL GRADING ON THIS SITE WILL BE DONE IN ACCORDANCE WITH THE CURRENT GRADING REQUIREMENTS AS SET FORTH BY THE BALTIMORE COUNTY DEPARTMENT OF ENVIRONMENTAL PROTECTION AND SUSTAINABILITY AND WITH THE REQUIREMENTS SPECIFIED IN ARTICLE 33, TITLE 5 OF THE BALTIMORE COUNTY CODE.

*Gregory A. Dorn* **FACILITIES CHIEF** 01/31/2021  
SIGNATURE OF OWNER/DEVELOPER TITLE DATE  
**GREGORY A. DORN**  
PRINT NAME

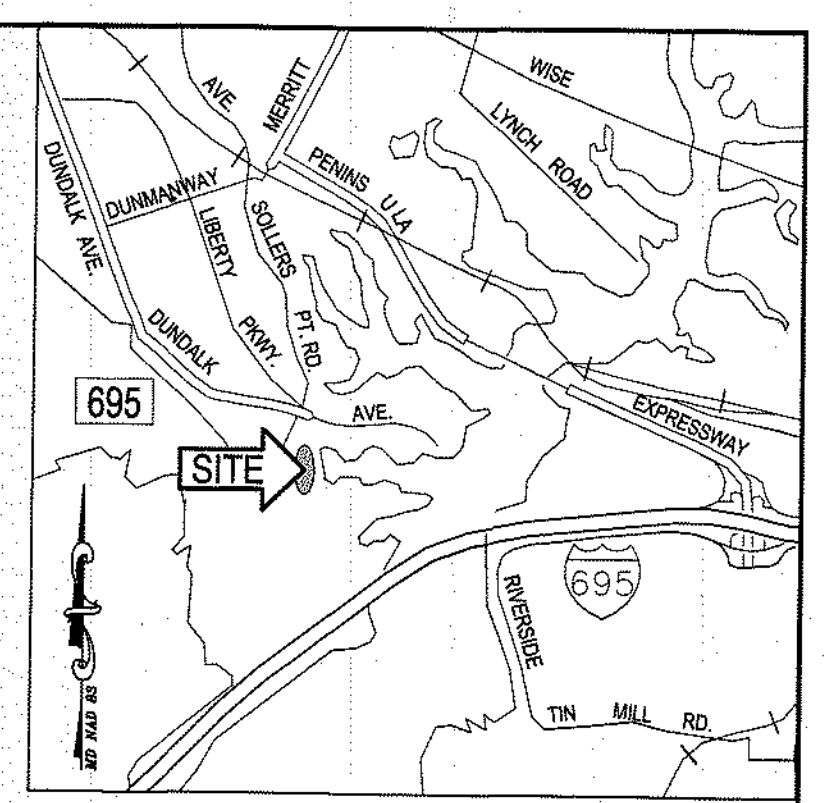

**LEGEND**

DESCRIPTION	EXISTING
BUILDING	EX. BLDG
BITUMINOUS CONCRETE PAVING	EX. MACADAM
PORTLAND CEMENT CONCRETE	EX. CONC.
CLEAN OUT	CO
DRAIN INLET	DI
FIRE HYDRANT	FD
POWER POLE	PP
SANITARY MH	SMH
SIGN (ONE-POST)	SP
STORM DRAIN MH	SDMH
STREET LIGHT	SL
TRAVERSE STATION	TS
WATER VALVE	WV
SPOT ELEVATION	SE
MAJOR CONTOUR	MC
MINOR CONTOUR	ML
CONC. CURB	CC
SURVEY LIMITS	SL
WOOD FENCE	WF
GUARDRAIL	GR
UG ELECTRIC	UE
UG STORM	US
UG WATER	UW
UG TELEPHONE	UT
UG IRRIGATION	UI
FLOW ARROW	FA
SOIL BORING	SB
SOIL LINE	SL
FLOOD PLAN	FP
CRITICAL AREA BUFFER	CAB

**GRADING LEGEND**

NEW MAJOR CONTOUR	5
NEW MINOR CONTOUR	4
NEW SPOT ELEVATION	4.50
FLOW ARROW	FA
NEW STORM DRAIN	SD
NEW INLET	DI
NEW INLET	DI
LIMIT OF DISTURBANCE	LOD

**STORM DRAIN NOTES**  
SD-1 PROPOSED 12" HDPE PIPE  
SD-2 PROPOSED PIPE COUPLER. SEE DETAIL #4 ON SITE DETAILS.  
SD-3 PROPOSED 15" W/10" OR LARGER DRAIN BASIN INLET WITH 15" STANDARD GRATE ASSEMBLY. SEE DETAIL #5 ON SITE DETAILS.


**OWNER**  
PROPERTY MANAGEMENT, CAPITAL SERVICES  
12200 LONG GREEN PIKE  
GLEN ARM, MD 21057  
BRIAN MCKINLEY  
410-887-2915  
SITE ADDRESS:  
323 SOLLERS POINT RD, DUNDALK, MD 21222  
COORDINATES SHOWN HEREON ARE REFERRED TO THE MARYLAND STATE PLANE COORDINATE SYSTEM, NAD 83 (1981).  
ELEVATIONS SHOWN HEREON ARE REFERRED TO THE NORTH AMERICAN VERTICAL DATUM OF 1988 (NAVD 88).

**CONTRACT COMPLETION BOX**

CONTRACTOR:	
DATE COMPLETED:	
INSPECTOR:	
PIPE MATERIAL (Pressure Only):	

	<b>PROFESSIONAL CERTIFICATION</b>		AS-BUILT / REVISION	BY	DATE	P.W.A. NO.	KEY SHEET	POSITION SH	DRAWING SCALE	DEPARTMENT OF PUBLIC WORKS	
	I HEREBY CERTIFY THAT THESE DOCUMENTS WERE PREPARED OR APPROVED BY ME, AND THAT I AM A FULLY LICENSED PROFESSIONAL ENGINEER UNDER THE LAWS OF THE STATE OF MARYLAND.									APPROVED BY: _____	
	LICENSE NO. 34682 EXPIRATION DATE 07/08/23									DATE: _____	
	ENGINEER: <b>BLAINE LINKOUS</b>									DIRECTOR	
	BUREAU OF ENGINEERING AND CONSTRUCTION		TRAFFIC	HIGHWAYS	STRUCTURES	STORM DRAINS	SEWER	WATER	FIELD ENGINEER	BUR. OF ENGINEERING & CONSTRUCTION	
	DGN BY: K.H.									APPROVED BY: _____	
	DWN BY: H.H.									DATE: _____	
	CHKD BY: B.L.									CHIEF	
DATE REVIEWED:											


BALTIMORE COUNTY OFFICE OF BUDGET AND FINANCE, PROPERTY MANAGEMENT  
FIELD, TRACK, AND DRAINAGE REPLACEMENT  
**GRADING PLAN**  
SOLLERS POINT MULTIPURPOSE CENTER  
323 SOLLERS POINT RD.  
DUNDALK, MD 21222  
SUBDIVISION: SOLLERS POINT

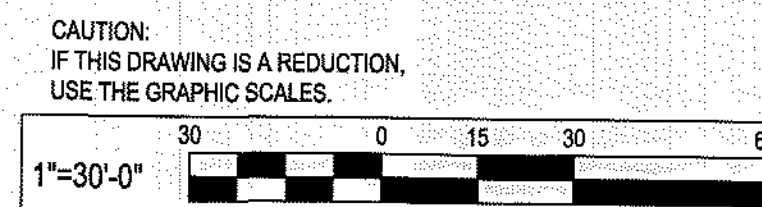

COUNCILMATIC DISTRICT: 7  
CONGRESSIONAL DISTRICT: 2  
LEGISLATIVE DISTRICT: 6  
ELECTION DIST. NO.: 12C7

	<b>SHEET DESIGNATION</b>	2021-2874	<b>CONTRACT NUMBER</b>	22005 P00
	<b>JOB ORDER NUMBER</b>	242-212-307-0472	<b>SHEET 6 OF 15</b>	
	<b>DRAWING NUMBER</b>	<b>C301</b>	<b>FILE NO.</b>	



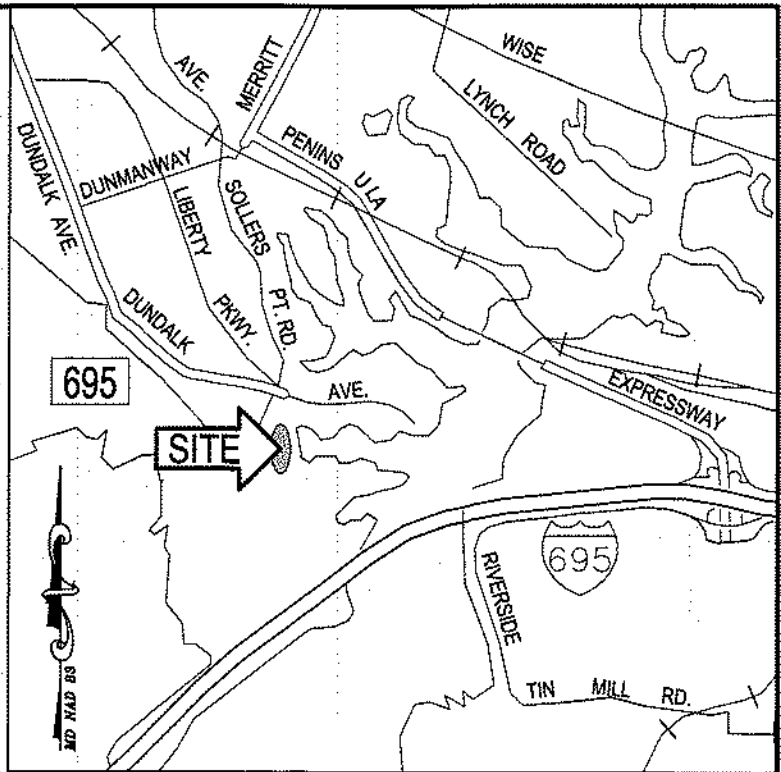

VICINITY MAP  
SCALE: 1" = 1000'

STRUCTURE SCHEDULE					
NO.	DESCRIPTION	INVERTS	NORTHING	EASTING	TOP ELEV.
I-100	NEW 15" NYLOPLAST DRAIN BASIN INLET WITH 15" STANDARD GRATE ASSEMBLY	INV OUT 2.919	N 574565.70	E 1451449.35	5.42
I-101	NEW 15" NYLOPLAST DRAIN BASIN INLET WITH 15" STANDARD GRATE ASSEMBLY	INV IN 2.355 INV OUT 2.165	N 574515.35	E 1451479.04	5.36
I-102	NEW 15" NYLOPLAST DRAIN BASIN INLET WITH 15" STANDARD GRATE ASSEMBLY	INV IN 1.698 INV OUT 1.498	N 574472.35	E 1451492.26	5.36

STRUCTURE SCHEDULE					
NO.	DESCRIPTION	INVERTS	NORTHING	EASTING	TOP ELEV.
I-200	NEW 15" NYLOPLAST DRAIN BASIN INLET WITH 15" STANDARD GRATE ASSEMBLY	INV OUT 2.813	N 574155.54	E 1451578.45	5.38
I-201	NEW 15" NYLOPLAST DRAIN BASIN INLET WITH 15" STANDARD GRATE ASSEMBLY	INV IN 2.294 INV OUT 2.064	N 574214.44	E 1451572.13	5.36
I-202	NEW 15" NYLOPLAST DRAIN BASIN INLET WITH 15" STANDARD GRATE ASSEMBLY	INV IN 1.435 INV OUT 1.271	N 574257.43	E 1451558.82	5.36
I-203	NEW 15" NYLOPLAST DRAIN BASIN INLET WITH 15" STANDARD GRATE ASSEMBLY	INV IN 2.130 INV OUT 1.930	N 574300.42	E 1451545.50	5.36
I-204	NEW 15" NYLOPLAST DRAIN BASIN INLET WITH 15" STANDARD GRATE ASSEMBLY	INV IN 2.551 INV OUT 2.351	N 574343.40	E 1451532.19	5.36
I-205	NEW 15" NYLOPLAST DRAIN BASIN INLET WITH 15" STANDARD GRATE ASSEMBLY	INV IN 2.985 INV OUT 2.785	N 574386.39	E 1451518.88	5.36
I-206	NEW 15" NYLOPLAST DRAIN BASIN INLET WITH 15" STANDARD GRATE ASSEMBLY	INV OUT 3.214	N 574429.37	E 1451505.57	5.36

STRUCTURE SCHEDULE					
NO.	DESCRIPTION	INVERTS	NORTHING	EASTING	TOP ELEV.
I-300	NEW 15" NYLOPLAST DRAIN BASIN INLET WITH 15" STANDARD GRATE ASSEMBLY	INV OUT 2.227	N 574109.16	E 1451051.38	5.54
I-301	NEW 15" NYLOPLAST DRAIN BASIN INLET WITH 15" STANDARD GRATE ASSEMBLY	INV IN 1.803 INV OUT 1.603	N 574081.50	E 1451057.28	5.36
I-302	NEW 15" NYLOPLAST DRAIN BASIN INLET WITH 15" STANDARD GRATE ASSEMBLY	INV IN 2.502 INV OUT 2.302	N 574079.58	E 1451454.53	5.54
I-303	NEW 15" NYLOPLAST DRAIN BASIN INLET WITH 15" STANDARD GRATE ASSEMBLY	INV IN 3.284 INV OUT 3.084	N 574104.18	E 1451408.25	5.36
I-304	NEW 15" NYLOPLAST DRAIN BASIN INLET WITH 15" STANDARD GRATE ASSEMBLY	INV OUT 3.530	N 574154.53	E 1451378.64	5.36

STRUCTURE SCHEDULE					
NO.	DESCRIPTION	INVERTS	NORTHING	EASTING	TOP ELEV.
I-400	NEW 15" NYLOPLAST DRAIN BASIN INLET WITH 15" STANDARD GRATE ASSEMBLY	INV IN 1.636 INV OUT 1.436	N 574197.48	E 1451365.34	5.36
I-401	NEW 15" NYLOPLAST DRAIN BASIN INLET WITH 15" STANDARD GRATE ASSEMBLY	INV IN 2.295 INV OUT 2.095	N 574240.50	E 1451352.02	5.36
I-402	NEW 15" NYLOPLAST DRAIN BASIN INLET WITH 15" STANDARD GRATE ASSEMBLY	INV IN 2.949 INV OUT 2.749	N 574283.49	E 1451338.71	5.36
I-403	NEW 15" NYLOPLAST DRAIN BASIN INLET WITH 15" STANDARD GRATE ASSEMBLY	INV OUT 3.174	N 574328.45	E 1451325.38	5.36

STRUCTURE SCHEDULE					
NO.	DESCRIPTION	INVERTS	NORTHING	EASTING	TOP ELEV.
I-500	NEW 15" NYLOPLAST DRAIN BASIN INLET WITH 15" STANDARD GRATE ASSEMBLY	INV OUT 1.873	N 574369.46	E 1451312.09	5.36
I-501	NEW 15" NYLOPLAST DRAIN BASIN INLET WITH 15" STANDARD GRATE ASSEMBLY	INV IN 1.600 INV OUT 1.600	N 574412.45	E 1451298.78	5.36
I-502	NEW 15" NYLOPLAST DRAIN BASIN INLET WITH 15" STANDARD GRATE ASSEMBLY	INV IN 1.790 INV OUT 1.790	N 574455.44	E 1451285.47	5.36
I-503	NEW 15" NYLOPLAST DRAIN BASIN INLET WITH 15" STANDARD GRATE ASSEMBLY	INV IN 2.100 INV OUT 2.080	N 574514.43	E 1451281.80	5.42
I-504	NEW 15" NYLOPLAST DRAIN BASIN INLET WITH 15" STANDARD GRATE ASSEMBLY	INV IN 2.410 INV OUT 2.400	N 574560.72	E 1451308.22	5.50
I-505	NEW 15" NYLOPLAST DRAIN BASIN INLET WITH 15" STANDARD GRATE ASSEMBLY	INV IN 2.850 INV OUT 2.830	N 574598.38	E 1451350.32	5.36
I-506	NEW 15" NYLOPLAST DRAIN BASIN INLET WITH 15" STANDARD GRATE ASSEMBLY	INV OUT 3.200	N 574590.31	E 1451403.07	5.50

STANDARD NOTES:

- THE CONTRACTOR SHALL MAINTAIN, REPAIR, AND/OR REPLACE ANY EXISTING SEDIMENT CONTROL DEVICES ENCOUNTERED AND DISTURBED DURING THE COURSE OF CONSTRUCTION UNDER THIS CONTRACT, AND AS SHOWN ON THE APPROVED SEDIMENT CONTROL PLAN AS PART OF THE CONTRACT DOCUMENTS. AT THE END OF EACH DAY, ALL SUCH DISTURBED DEVICES SHALL BE REPAIRED OR REPLACED BEFORE LEAVING THE WORK SITE. THE COST OF PERFORMING THE WORK, INCLUDING MATERIALS, SHALL BE PAID FOR BY A LUMP SUM BID FOR MAINTENANCE AND REPAIR OF SEDIMENT CONTROL DEVICES.
- ALL WORK UNDER THIS CONTRACT SHALL BE PERFORMED BY THE CONTRACTOR IN ACCORDANCE WITH BALTIMORE COUNTY SOIL CONSERVATION DISTRICT PERMIT NUMBER \_\_\_\_ - COUNTY - \_\_\_\_.
- ALL CONSTRUCTION SHALL BE ACCOMPLISHED IN ACCORDANCE WITH BALTIMORE COUNTY STANDARD SPECIFICATIONS AND DETAILS FOR CONSTRUCTION (FEBRUARY 2000, AS AMENDED).
- THE CONTRACTOR SHALL MAINTAIN TRAFFIC AT ALL TIMES.
- THE CONTRACTOR SHALL USE EXTREME CAUTION DURING EXCAVATION AND/OR INSTALLATION OF ALL WORK SHOWN ON THESE PLANS. ALL UTILITIES SHALL BE FULLY PROTECTED FROM DAMAGE OR INTERRUPTION.
- \*A FOREST CONSERVATION SPECIAL VARIANCE WAS APPROVED BY THE BALTIMORE COUNTY DEPARTMENT OF ENVIRONMENTAL PROTECTION AND SUSTAINABILITY TO ALLOW THE REMOVAL OF FIVE SPECIMEN TREES. MITIGATION WAS ACCOMPLISHED THROUGH THE PAYMENT OF A FEE-IN-LIEU.\*

GRADING NOTES:

- THE PROPOSED GRADING ON THIS PLAN MEETS THE REQUIREMENTS SET FORTH BY BALTIMORE COUNTY DEPARTMENT OF ENVIRONMENTAL PROTECTION AND SUSTAINABILITY AND COMPLIES WITH ARTICLE 33, TITLE 5 OF THE BALTIMORE COUNTY CODE. HOWEVER, DUE TO BUILDING TYPES AND LAYOUT, SOME FIELD ADJUSTMENTS MAY BE REQUIRED. ALL CHANGES MUST COMPLY WITH THE ABOVE MENTIONED REQUIREMENTS.
- ALL SWALES HAVE BEEN DESIGNED BY THE ENGINEER TO CONVEY RUNOFF ACCORDING TO BALTIMORE COUNTY DEPARTMENT OF PUBLIC WORKS DESIGN STANDARDS.
- THERE SHALL BE NO CLEARING, GRADING, CONSTRUCTION OR DISTURBANCE OF VEGETATION IN FOREST BUFFER EASEMENT OR OTHER FOREST RETENTION AREAS EXCEPT AS PERMITTED BY THE BALTIMORE COUNTY DEPARTMENT OF ENVIRONMENTAL PROTECTION AND SUSTAINABILITY.
- STORMWATER MANAGEMENT HAS BEEN ADDRESSED BY A STORMWATER MANAGEMENT VARIANCE.
- TOTAL AREA DISTURBED IS 3.88 AC / +/-169110 SF.

OWNER

PROPERTY MANAGEMENT, CAPITAL SERVICES  
12200 LONG GREEN PIKE  
GLEN ARM, MD 21057  
BRIAN MCKINLEY  
410-887-2015  
SITE ADDRESS:  
323 SOLLERS POINT RD, DUNDALK, MD 21222  
COORDINATES SHOWN HEREON ARE REFERRED TO THE MARYLAND  
STATE PLANE COORDINATE SYSTEM, NAD 83 (1991).  
ELEVATIONS SHOWN HEREON ARE REFERRED TO THE NORTH AMERICAN  
VERTICAL DATUM OF 1988 (NAVD 88).

CONTRACT COMPLETION BOX

CONTRACTOR: \_\_\_\_\_  
DATE COMPLETED: \_\_\_\_\_  
INSPECTOR: \_\_\_\_\_  
PIPE MATERIAL (Pressure Only): \_\_\_\_\_

CAUTION:  
IF THIS DRAWING IS A REDUCTION,  
USE THE GRAPHIC SCALES.



SHEET DESIGNATION	CONTRACT NUMBER
2021-2875	22005 PO0
JOB ORDER NUMBER	
242-212-307-0472	
SHEET 7 OF 15	
DRAWING NUMBER	
C302	
FILE NO.:	

SEAL	PROFESSIONAL CERTIFICATION	AS-BUILT / REVISION	BY	DATE	P.W.A. NO.	KEY SHEET	POSITION SH	DRAWING SCALE	DEPARTMENT OF PUBLIC WORKS	
	I HEREBY CERTIFY THAT THESE DOCUMENTS WERE PREPARED OR APPROVED BY ME, AND THAT I AM A DULY LICENSED PROFESSIONAL ENGINEER UNDER THE LAWS OF THE STATE OF MARYLAND.				R.O.W NO.	MNE	37 NE 32 38 NE 32	PLAN SCALE: 1" = 30' PROFILE SCALE:	APPROVED BY: _____ DATE: _____	
	ENGINEER: BLAINE LINKOUS	DON BY: K.H.	BUREAU OF ENGINEERING AND CONSTRUCTION	TRAFFIC	HIGHWAYS	STRUCTURES	STORM DRAINS	SEWER	WATER	FIELD ENGINEER
	TWBCM	DWN BY: H.H.	REVIEWED BY:							APPROVED BY: _____ DATE: _____
	DATE: 09/11/21	CHD BY: B.L.	DATE REVIEWED:							CHIEF


SIGNATURE OF OWNER/DEVELOPER:   
TITLE: FACILITIES CHIEF  
DATE: 8/31/2021

BALTIMORE COUNTY OFFICE OF BUDGET AND FINANCE, PROPERTY MANAGEMENT  
FIELD, TRACK, AND DRAINAGE REPLACEMENT  
GRADING PLAN  
SOLLERS POINT MULTIPURPOSE CENTER  
323 SOLLERS POINT RD.  
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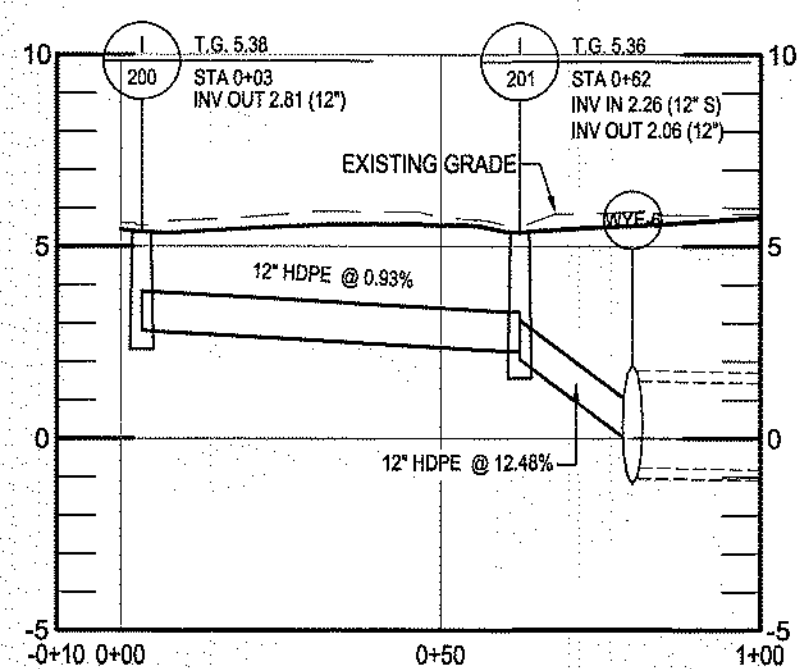
COUNCILMATIC DISTRICT: 7  
CONGRESSIONAL DISTRICT: 2  
LEGISLATIVE DISTRICT: 6  
ELECTION DIST. NO.: 12c7

SUBDIVISION: SOLLERS POINT




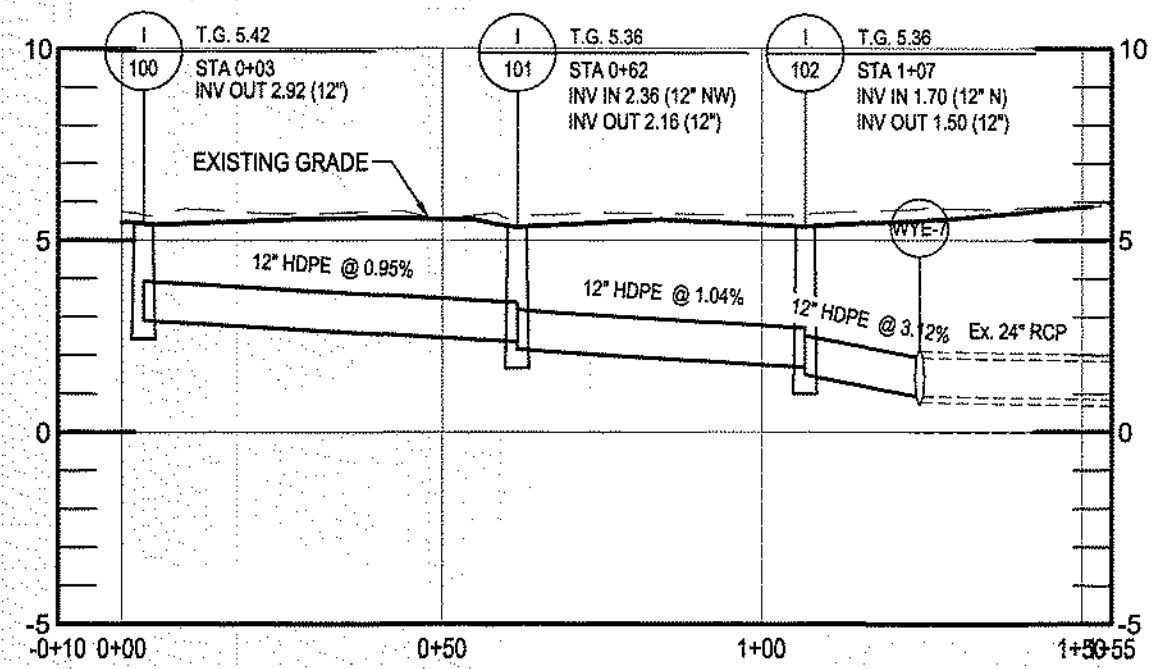


I-100 TO I-102  
SCALE: HORIZ. 1"=30' VERT. 1"=5'




I-200 TO I-201  
SCALE: HORIZ. 1"=30' VERT. 1"=5'

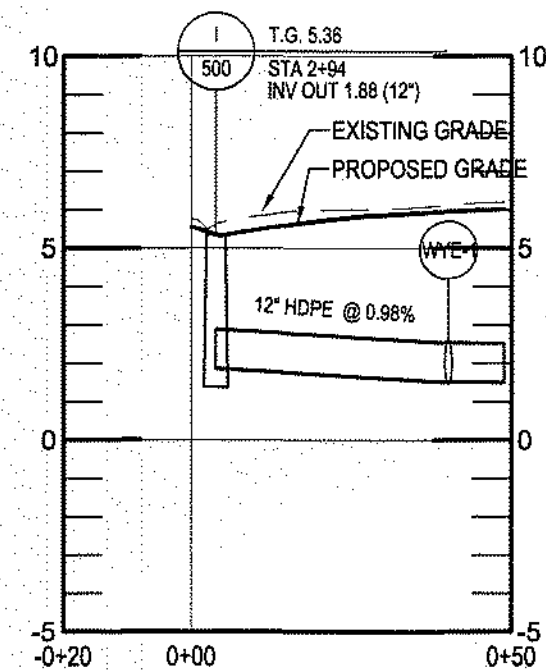


I-500 TO COUPLING  
SCALE: HORIZ. 1"=30' VERT. 1"=5'

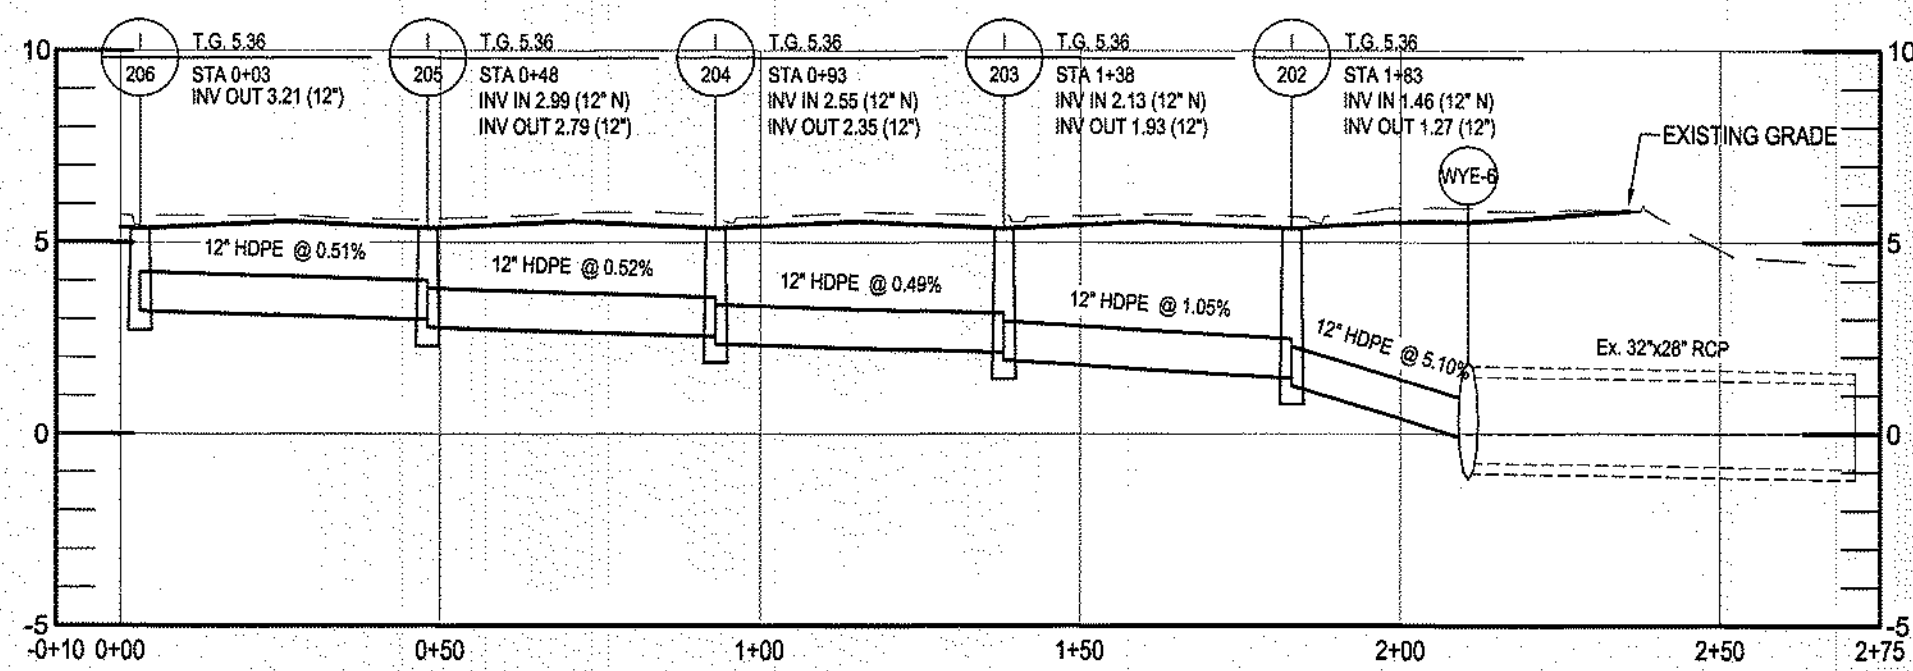


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I-403 TO I-400  
SCALE: HORIZ. 1"=30' VERT. 1"=5'

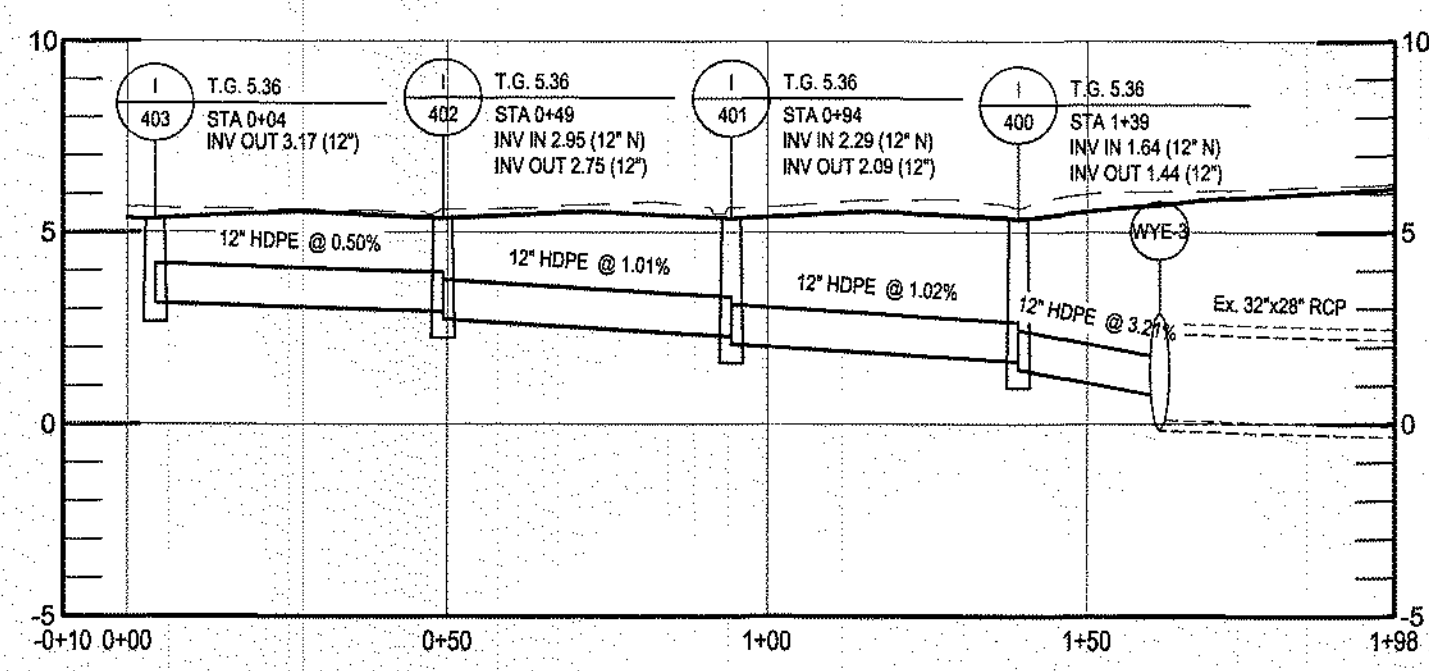

I-506 TO I-501  
SCALE: HORIZ. 1"=30' VERT. 1"=5'

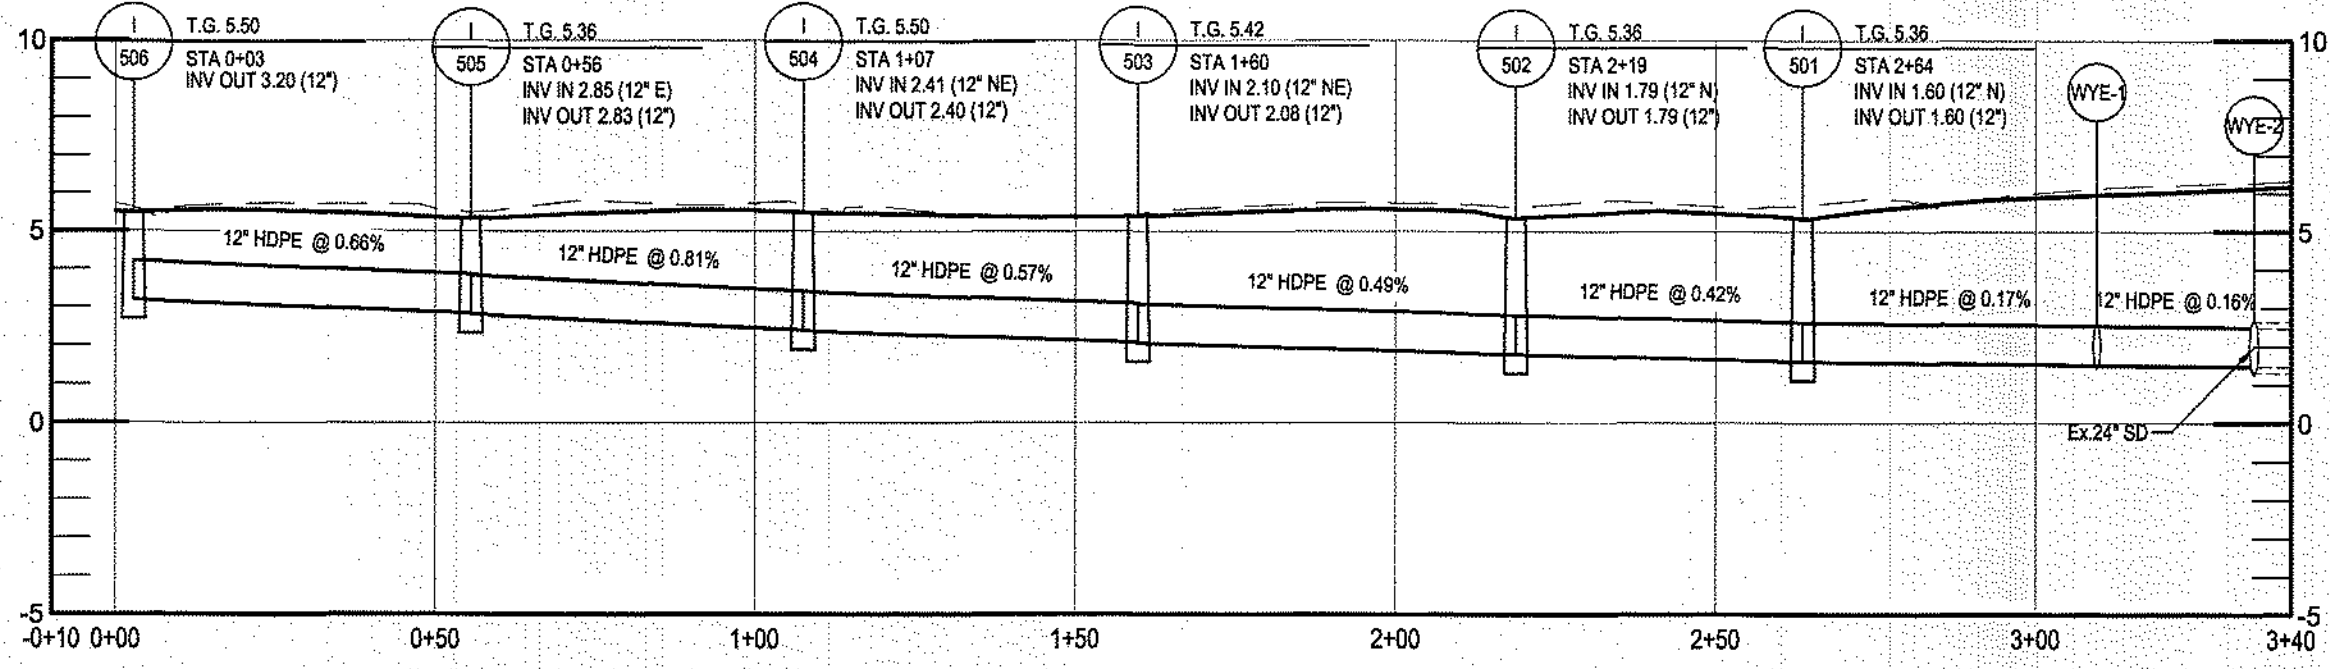


I-304 TO I-300  
SCALE: HORIZ. 1"=30' VERT. 1"=5'

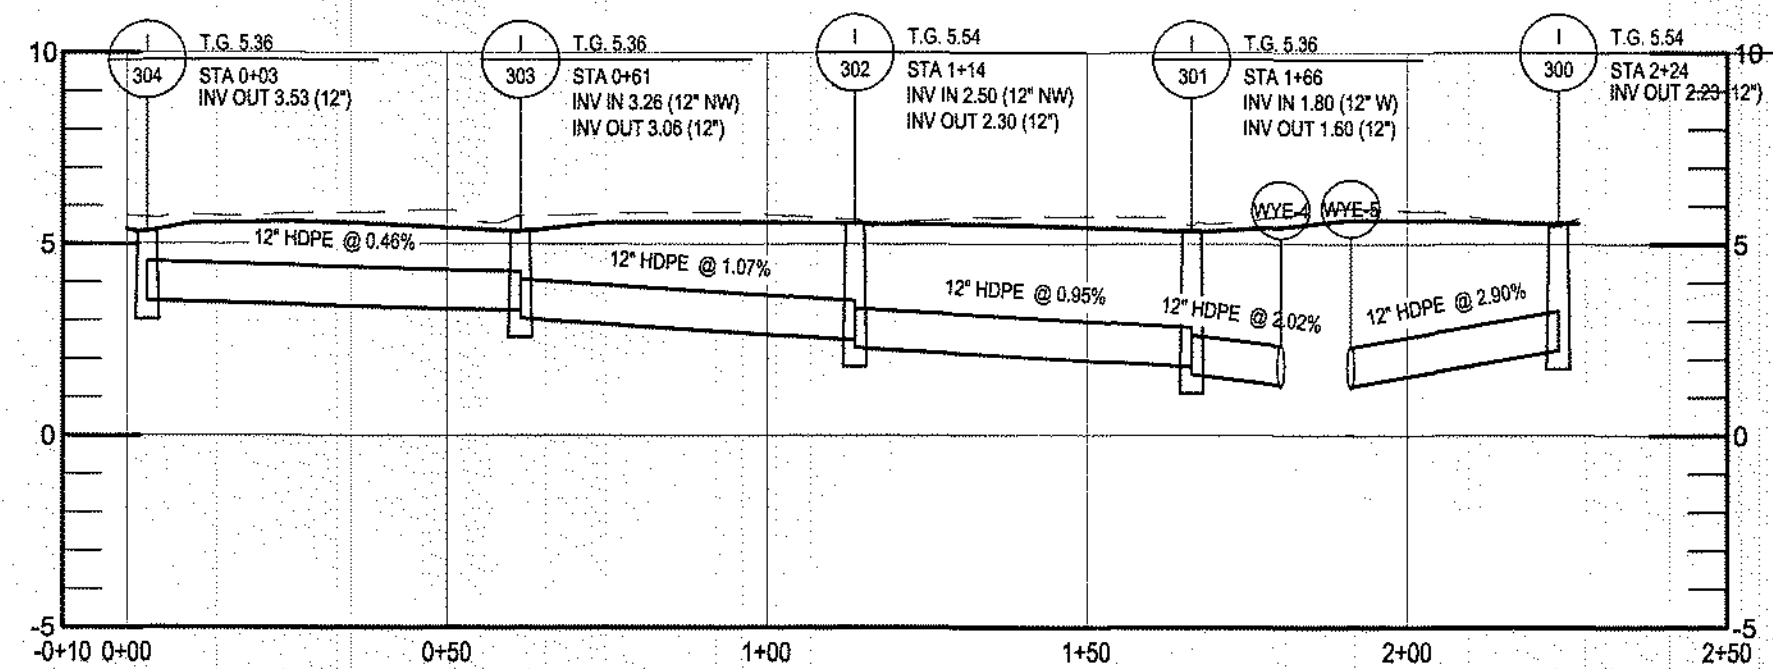**OWNER**  
PROPERTY MANAGEMENT, CAPITAL SERVICES  
12200 LONG GREEN PIKE  
GLEN ARM, MD 21057  
BRIAN MCKINLEY  
410-887-2915  
SITE ADDRESS:  
323 SOLLERS POINT RD, DUNDALK, MD 21222  
COORDINATES SHOWN HEREON ARE REFERRED TO THE MARYLAND  
STATE PLANE COORDINATE SYSTEM, NAD 83 (1991).  
ELEVATIONS SHOWN HEREON ARE REFERRED TO THE NORTH AMERICAN  
VERTICAL DATUM OF 1988 (NAVD 88).


CONTRACT COMPLETION BOX	
CONTRACTOR:	
DATE COMPLETED:	
INSPECTOR:	
PIPE MATERIAL (Pressure Only):	

*A M Linn*  
SIGNATURE OF OWNER/DEVELOPER  
FACILITIES CHIEF  
08/31/2021  
DATE

CAUTION:  
IF THIS DRAWING IS A REDUCTION,  
USE THE GRAPHIC SCALES.

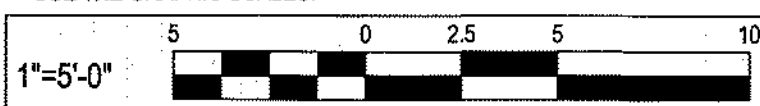

CAUTION:  
IF THIS DRAWING IS A REDUCTION,  
USE THE GRAPHIC SCALES.

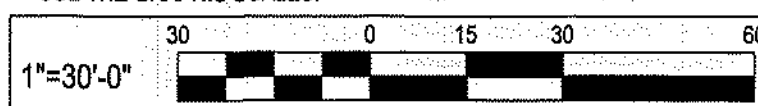

PROFESSIONAL CERTIFICATION		AS-BUILT / REVISION		BY	DATE	P.W.A. NO.	KEY SHEET	POSITION	SHT	DRAWING SCALE	DEPARTMENT OF PUBLIC WORKS	
I HEREBY CERTIFY THAT THESE DOCUMENTS WERE PREPARED OR APPROVED BY ME, AND THAT I AM A FULLY LICENSED PROFESSIONAL ENGINEER UNDER THE LAWS OF THE STATE OF MARYLAND.											APPROVED BY: _____	
LICENSE NO. 34682 EXPIRATION DATE 07/08/23											DATE: _____	
ENGINEER: BLAINE LINKOUS		DGN BY: K.H.		BUREAU OF ENGINEERING AND CONSTRUCTION		TRAFFIC		HIGHWAYS		STRUCTURES		
WBCM		DWN BY: H.H.		REVIEWED BY:						APPROVED BY: _____		
		CHD BY: B.L.		DATE REVIEWED:						DATE: _____		

BALTIMORE COUNTY OFFICE OF BUDGET AND FINANCE, PROPERTY MANAGEMENT  
FIELD, TRACK, AND DRAINAGE REPLACEMENT  
**UTILITIES PROFILE**  
SOLLERS POINT MULTIPURPOSE CENTER  
323 SOLLERS POINT RD.  
DUNDALK, MD 21222

COUNCILMATIC DISTRICT: 7  
CONGRESSIONAL DISTRICT: 2  
LEGISLATIVE DISTRICT: 6  
ELECTION DIST. NO.: 12c7

SHEET DESIGNATION	CONTRACT NUMBER
2021-2876	22005 POO
JOB ORDER NUMBER	
242-212-307-0472	
SHEET 8 OF 15	
DRAWING NUMBER	
C401	
FILE NO.: _____	








#### B-4 STANDARDS AND SPECIFICATIONS FOR VEGETATIVE STABILIZATION

**DEFINITION**  
USING VEGETATION AS COVER TO PROTECT EXPOSED SOIL FROM EROSION.  
**PURPOSE**  
TO PROMOTE THE ESTABLISHMENT OF VEGETATION ON EXPOSED SOIL.  
**CONDITIONS WHERE PRACTICE APPLIES**  
ON ALL DISTURBED AREAS NOT STABILIZED BY OTHER METHODS. THIS SPECIFICATION IS DIVIDED INTO SECTIONS ON INCREMENTAL STABILIZATION, SOIL PREPARATION, SOIL AMENDMENTS AND TOPSOILING, SEEDING AND MULCHING, TEMPORARY STABILIZATION, AND PERMANENT STABILIZATION.  
**EFFECTS ON WATER QUALITY AND QUANTITY**  
STABILIZATION PRACTICES ARE USED TO PROMOTE THE ESTABLISHMENT OF VEGETATION ON EXPOSED SOIL. WHEN SOIL IS STABILIZED WITH VEGETATION, THE SOIL IS LESS LIKELY TO ERODE AND MORE LIKELY TO ALLOW INFILTRATION OF RAINFALL, THEREBY REDUCING SEDIMENT LOADS AND RUNOFF TO DOWNSTREAM AREAS.  
PLANTING VEGETATION IN DISTURBED AREAS WILL HAVE AN EFFECT ON THE WATER BUDGET, ESPECIALLY ON VOLUMES AND RATES OF RUNOFF, INFILTRATION, EVAPORATION, TRANSPARATION, PERCOLATION, AND GROUNDWATER RECHARGE. OVER TIME, VEGETATION WILL INCREASE ORGANIC MATTER CONTENT AND IMPROVE THE WATER HOLDING CAPACITY OF THE SOIL AND SUBSEQUENT PLANT GROWTH.  
VEGETATION WILL HELP REDUCE THE MOVEMENT OF SEDIMENT, NUTRIENTS, AND OTHER CHEMICALS CARRIED BY RUNOFF TO RECEIVING WATERS. PLANTS WILL ALSO HELP PROTECT GROUNDWATER SUPPLIES BY ASSIMILATING TOXIC SUBSTANCES WITHIN THE ROOT ZONE.  
SEDIMENT CONTROL PRACTICES MUST REMAIN IN PLACE DURING GRADING, SEEDED PREPARATION, SEEDING, MULCHING, AND VEGETATIVE ESTABLISHMENT.  
**ADEQUATE VEGETATIVE ESTABLISHMENT**  
INSPECT SEEDED AREAS FOR VEGETATIVE ESTABLISHMENT AND MAKE NECESSARY REPAIRS, REPLACEMENTS, AND RESEEDINGS WITHIN THE PLANTING SEASON.  
1. ADEQUATE VEGETATIVE STABILIZATION REQUIRES 85 PERCENT GROUND COVER.  
2. IF AN AREA HAS LESS THAN 40 PERCENT GROUND COVER, RESEEDING FOLLOWING THE ORIGINAL RECOMMENDATIONS FOR LIME, FERTILIZER, SEEDING PREPARATION, AND SEEDING.  
3. IF AN AREA HAS BETWEEN 40 AND 94 PERCENT GROUND COVER, OVER SEED AND FERTILIZE USING HALF OF THE RATES ORIGINALLY SPECIFIED.  
4. MAINTENANCE FERTILIZER RATES FOR PERMANENT SEEDING ARE SHOWN IN TABLE B.6.


#### B-4-1 STANDARDS AND SPECIFICATIONS FOR INCREMENTAL STABILIZATION

**DEFINITION**  
ESTABLISHMENT OF VEGETATIVE COVER ON CUT AND FILL SLOPES.  
**PURPOSE**  
TO PROVIDE TIMELY VEGETATIVE COVER ON CUT AND FILL SLOPES AS WORK PROGRESSES.  
**CONDITIONS WHERE PRACTICE APPLIES**  
ANY CUT OR FILL SLOPE GREATER THAN 15 FEET IN HEIGHT. THIS PRACTICE ALSO APPLIES TO STOCKPILES.  
**CRITERIA**  
A. INCREMENTAL STABILIZATION - CUT SLOPES  
1. EXCAVATE AND STABILIZE CUT SLOPES IN INCREMENTS NOT TO EXCEED 15 FEET IN HEIGHT. PREPARE SEEDED AND APPLY SEED AND MULCH ON ALL CUT SLOPES AS THE WORK PROGRESSES.  
2. CONSTRUCTION SEQUENCE EXAMPLE (REFER TO FIGURE B.1):  
a. CONSTRUCT AND STABILIZE ALL TEMPORARY SWALES OR DIKES THAT WILL BE USED TO CONVEY RUNOFF AROUND THE EXCAVATION.  
b. PERFORM PHASE 1 EXCAVATION, PREPARE SEEDED, AND STABILIZE. OVERSEED PREVIOUSLY SEEDED AREAS AS NECESSARY.  
c. PERFORM PHASE 2 EXCAVATION, PREPARE SEEDED, AND STABILIZE. OVERSEED PREVIOUSLY SEEDED AREAS AS NECESSARY.  
d. PERFORM FINAL PHASE EXCAVATION, PREPARE SEEDED, AND STABILIZE. OVERSEED PREVIOUSLY SEEDED AREAS AS NECESSARY.  
**NOTE:** ONCE EXCAVATION HAS BEGUN THE OPERATION SHOULD BE CONTINUOUS FROM GRUBBING THROUGH THE COMPLETION OF GRADING AND PLACEMENT OF TOPSOIL (IF REQUIRED) AND PERMANENT SEED AND MULCH. ANY INTERRUPTIONS IN THE OPERATION OR COMPLETING THE OPERATION OUT OF THE SEEDING SEASON WILL NECESSITATE THE APPLICATION OF TEMPORARY STABILIZATION.

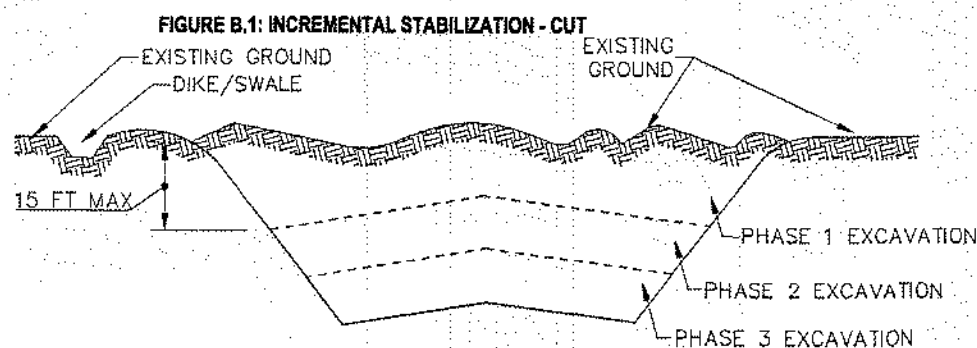

B. INCREMENTAL STABILIZATION - FILL SLOPES  
1. CONSTRUCT AND STABILIZE FILL SLOPES IN INCREMENTS NOT TO EXCEED 15 FEET IN HEIGHT. PREPARE SEEDED AND APPLY SEED AND MULCH ON ALL SLOPES AS THE WORK PROGRESSES.  
2. STABILIZE SLOPES IMMEDIATELY WHEN THE VERTICAL HEIGHT OF A LIFT REACHES 15 FEET, OR WHEN THE GRADING OPERATION CEASES AS PRESCRIBED IN THE PLANS.  
3. AT THE END OF EACH DAY, INSTALL TEMPORARY WATER CONVEYANCE PRACTICES(S), AS NECESSARY, TO INTERCEPT SURFACE RUNOFF AND CONVEY IT DOWN THE SLOPE IN A NON-EROSIVE MANNER.  
4. CONSTRUCTION SEQUENCE EXAMPLE (REFER TO FIGURE B.2):  
a. CONSTRUCT AND STABILIZE ALL TEMPORARY SWALES OR DIKES THAT WILL BE USED TO DIVERT RUNOFF AROUND THE FILL. CONSTRUCT SILT FENCE ON LOW SIDE OF FILL UNLESS OTHER METHODS SHOWN ON THE PLANS ADDRESS THIS AREA.  
b. AT THE END OF EACH DAY, INSTALL TEMPORARY WATER CONVEYANCE PRACTICES(S), AS NECESSARY, TO INTERCEPT SURFACE RUNOFF AND CONVEY IT DOWN THE SLOPE IN A NON-EROSIVE MANNER.  
c. PLACE PHASE 1 FILL, PREPARE SEEDED, AND STABILIZE.  
d. PLACE PHASE 2 FILL, PREPARE SEEDED, AND STABILIZE.  
e. PLACE FINAL PHASE FILL, PREPARE SEEDED, AND STABILIZE. OVERSEED PREVIOUSLY SEEDED AREAS AS NECESSARY.

**NOTE:** ONCE THE PLACEMENT OF FILL HAS BEGUN THE OPERATION SHOULD BE CONTINUOUS FROM GRUBBING THROUGH THE COMPLETION OF GRADING AND PLACEMENT OF TOPSOIL (IF REQUIRED) AND PERMANENT SEED AND MULCH. ANY INTERRUPTIONS IN THE OPERATION OR COMPLETING THE OPERATION OUT OF THE SEEDING SEASON WILL NECESSITATE THE APPLICATION OF TEMPORARY STABILIZATION.

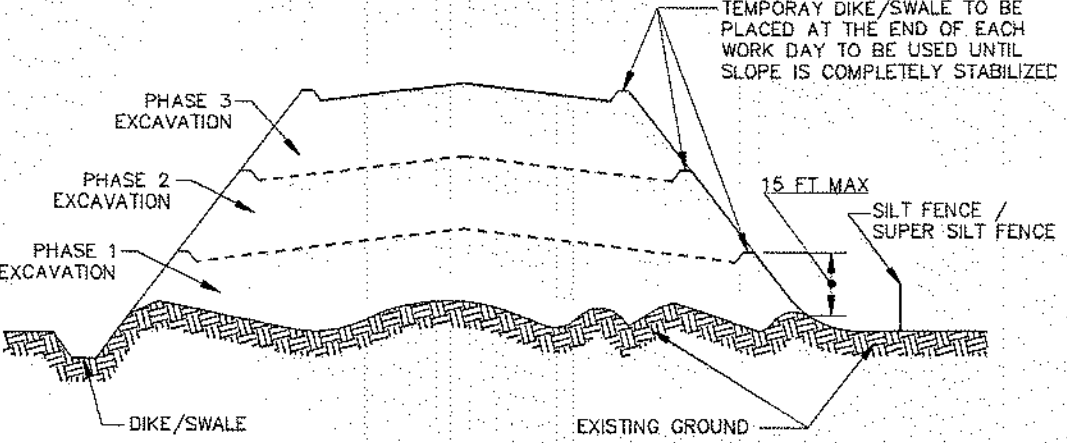

#### B-4-2 SOIL PREPARATION, TOPSOILING, AND SOIL AMENDMENTS

A. SOIL PREPARATION  
1. TEMPORARY STABILIZATION  
a. SEEDED PREPARATION CONSISTS OF LOOSENING SOIL TO A DEPTH OF 3 TO 5 INCHES BY MEANS OF SUITABLE AGRICULTURAL OR CONSTRUCTION EQUIPMENT, SUCH AS DISC HARROWS OR RIPPERS MOUNTED ON CONSTRUCTION EQUIPMENT. AFTER THE SOIL IS LOOSENED, IT MUST NOT BE ROLLED OR DRAGGED SMOOTH BUT LEFT IN THE ROUGHENED CONDITION. SLOPES 3:1 OR FLATTER ARE TO BE TRACKED WITH RIDGES RUNNING PARALLEL TO THE CONTOUR OF THE SLOPE.  
b. APPLY FERTILIZER AND LIME AS PRESCRIBED ON THE PLANS.  
c. INCORPORATE LIME AND FERTILIZER INTO THE TOP 3 TO 5 INCHES OF SOIL BY DISKING OR OTHER SUITABLE MEANS.  
2. PERMANENT STABILIZATION  
a. A SOIL TEST IS REQUIRED FOR ANY EARTH DISTURBANCE OF 5 ACRES OR MORE. THE MINIMUM SOIL CONDITIONS REQUIRED FOR PERMANENT VEGETATIVE ESTABLISHMENT ARE:  
i. SOIL PH BETWEEN 6.0 AND 7.0.  
ii. SOLUBLE SALTS LESS THAN 500 PARTS PER MILLION (PPM).  
iii. SOIL CONTAINS LESS THAN 40 PERCENT CLAY BUT ENOUGH FINE GRAINED MATERIAL (GREATER THAN 30 PERCENT SILT PLUS CLAY) TO PROVIDE THE CAPACITY TO HOLD A MODERATE AMOUNT OF MOISTURE. AN EXCEPTION: IF LOVEGRASS WILL BE PLANTED, THEN A SANDY SOIL (LESS THAN 30 PERCENT SILT PLUS CLAY) WOULD BE ACCEPTABLE.  
iv. SOIL CONTAINS 1.5 PERCENT MINIMUM ORGANIC MATTER BY WEIGHT.  
v. SOIL CONTAINS SUFFICIENT PORE SPACE TO PERMIT ADEQUATE ROOT PENETRATION.  
b. APPLICATION OF AMENDMENTS OR TOPSOIL IS REQUIRED IF ON-SITE SOILS DO NOT MEET THE ABOVE CONDITIONS.  
c. GRADED AREAS MUST BE MAINTAINED IN A TRUE AND EVEN GRADE AS SPECIFIED ON THE APPROVED PLAN, THEN SCARIFIED OR OTHERWISE LOOSENED TO A DEPTH OF 3 TO 5 INCHES.  
d. APPLY SOIL AMENDMENTS AS SPECIFIED ON THE APPROVED PLAN OR AS INDICATED BY THE RESULTS OF A SOIL TEST.  
e. MIX SOIL AMENDMENTS INTO THE TOP 3 TO 5 INCHES OF SOIL BY DISKING OR OTHER SUITABLE MEANS. RAKE LAWN AREAS TO SMOOTH THE SURFACE, REMOVE LARGE OBJECTS LIKE STONES AND BRANCHES, AND READY THE AREA FOR SEED APPLICATION. LOOSEN SURFACE SOIL BY DRAGGING WITH A HEAVY CHAIN OR OTHER EQUIPMENT TO ROUGHEN THE SURFACE WHERE SITE CONDITIONS WILL NOT PERMIT NORMAL SEEDED PREPARATION. TRACK SLOPES 3:1 OR FLATTER WITH TRACKED EQUIPMENT LEAVING THE SOIL IN AN IRREGULAR CONDITION WITH RIDGES RUNNING PARALLEL TO THE CONTOUR OF THE SLOPE. LEAVE THE TOP 1 TO 3 INCHES OF SOIL LOOSE AND FRAGILE. SEEDED LOOSENESS MAY BE UNNECESSARY ON NEWLY DISTURBED AREAS.  
B. TOPSOILING  
1. TOPSOIL IS PLACED OVER PREPARED SUBSOIL PRIOR TO ESTABLISHMENT OF PERMANENT VEGETATION. THE PURPOSE IS TO PROVIDE A SUITABLE SOIL MEDIUM FOR VEGETATIVE GROWTH. SOILS OF CONCERN HAVE LOW MOISTURE CONTENT, LOW NUTRIENT LEVELS, LOW PH, MATERIALS TOXIC TO PLANTS, AND/OR UNACCEPTABLE SOIL GRADATION.  
2. TOPSOIL, SALVAGED FROM AN EXISTING SITE MAY BE USED PROVIDED IT MEETS THE STANDARDS AS SET FORTH IN THESE SPECIFICATIONS. TYPICALLY, THE DEPTH OF TOPSOIL TO BE SALVAGED FOR A GIVEN SOIL TYPE CAN BE FOUND IN THE REPRESENTATIVE SOIL PROFILE SECTION IN THE SOIL SURVEY PUBLISHED BY USDA-NRCS.  
3. TOPSOILING IS LIMITED TO AREAS HAVING 2:1 OR FLATTER SLOPES WHERE:  
a. THE TEXTURE OF THE EXPOSED SUBSOIL/PARENT MATERIAL IS NOT ADEQUATE TO PRODUCE VEGETATIVE GROWTH.  
b. THE SOIL MATERIAL IS SO SHALLOW THAT THE ROOTING ZONE IS NOT DEEP ENOUGH TO SUPPORT PLANTS OR FURNISH CONTINUING SUPPLIES OF MOISTURE AND PLANT NUTRIENTS.  
c. THE ORIGINAL SOIL TO BE VEGETATED CONTAINS MATERIAL TOXIC TO PLANT GROWTH.  
d. THE SOIL IS SO ACIDIC THAT TREATMENT WITH LIMESTONE IS NOT FEASIBLE.  
4. AREAS HAVING SLOPES STEEPER THAN 2:1 REQUIRE SPECIAL CONSIDERATION AND DESIGN.  
5. TOPSOIL SPECIFICATIONS: SOIL TO BE USED AS TOPSOIL MUST MEET THE FOLLOWING CRITERIA:  
a. TOPSOIL MUST BE A LOAM, SANDY LOAM, CLAY LOAM, SILT LOAM, SANDY CLAY LOAM, OR LOAMY SAND. OTHER SOILS MAY BE USED IF RECOMMENDED BY AN AGRONOMIST OR SOIL SCIENTIST AND APPROVED BY THE APPROPRIATE APPROVAL AUTHORITY. TOPSOIL MUST NOT BE A MIXTURE OF CONTRASTING TEXTURED SUBSOILS AND MUST CONTAIN FEWER THAN 5 PERCENT BY VOLUME OF CONCRETE, STONES, SLAG, COARSE FRAGMENTS, GRAVEL, STICKS, ROOTS, TRASH, OR OTHER MATERIALS LARGER THAN 1 1/2 INCHES IN DIAMETER.  
b. TOPSOIL MUST BE FREE OF NOXIOUS PLANTS OR PLANT PARTS SUCH AS BERMUDA GRASS, QUACK GRASS, JOHNSON GRASS, NET SEDGE, POISON IVY, TIGER LIL, OR OTHERS AS SPECIFIED.  
c. TOPSOIL SUBSTITUTES OR AMENDMENTS, AS RECOMMENDED BY A QUALIFIED AGRONOMIST OR SOIL SCIENTIST AND APPROVED BY THE APPROPRIATE APPROVAL AUTHORITY, MAY BE USED IN LIEU OF NATURAL TOPSOIL.

6. TOPSOIL APPLICATION  
a. EROSION AND SEDIMENT CONTROL PRACTICES MUST BE MAINTAINED WHEN APPLYING TOPSOIL.  
b. UNIFORMLY DISTRIBUTE TOPSOIL IN A 5 TO 8 INCH LAYER AND LIGHTLY COMPACT TO A MINIMUM THICKNESS OF 4 INCHES. SPREADING IS TO BE PERFORMED IN SUCH A MANNER THAT SODDING OR SEEDING CAN PROCEED WITH A MINIMUM OF ADDITIONAL SOIL PREPARATION AND TILLAGE. ANY IRREGULARITIES IN THE SURFACE RESULTING FROM TOPSOILING OR OTHER OPERATIONS MUST BE CORRECTED IN ORDER TO PREVENT THE FORMATION OF DEPRESSIONS OR WATER POCKETS.  
c. TOPSOIL MUST NOT BE PLACED IF THE TOPSOIL OR SUBSOIL IS IN A FROZEN OR MUDDY CONDITION WHEN THE SUBSOIL IS EXCESSIVELY WET OR IN A CONDITION THAT MAY OTHERWISE BE DETRIMENTAL TO PROPER GRADING AND SEEDED PREPARATION.  
C. SOIL AMENDMENTS (FERTILIZER AND LIME SPECIFICATIONS)  
1. SOIL TESTS MUST BE PERFORMED TO DETERMINE THE EXACT RATIOS AND APPLICATION RATES FOR BOTH LIME AND FERTILIZER ON SITES HAVING DISTURBED AREAS OF 5 ACRES OR MORE. SOIL ANALYSIS MAY BE PERFORMED BY A RECOGNIZED PRIVATE OR COMMERCIAL LABORATORY. SOIL SAMPLES TAKEN FOR ENGINEERING PURPOSES MAY ALSO BE USED FOR CHEMICAL ANALYSES.  
2. FERTILIZERS MUST BE UNIFORM IN COMPOSITION, FREE FLOWING AND SUITABLE FOR ACCURATE APPLICATION BY APPROPRIATE EQUIPMENT. MANURE MAY BE SUBSTITUTED FOR FERTILIZER WITH PRIOR APPROVAL FROM THE APPROPRIATE APPROVAL AUTHORITY. FERTILIZERS MUST ALL BE DELIVERED TO THE SITE FULLY LABELED ACCORDING TO THE APPLICABLE LAWS AND MUST BEAR THE NAME, TRADE NAME OR TRADEMARK AND WARRANTY OF THE PRODUCER.  
3. LIME MATERIALS MUST BE GROUND LIMESTONE (HYDRATED OR BURNT LIME) MAY BE SUBSTITUTED EXCEPT WHEN HYDROSEEDING WHICH CONTAINS AT LEAST 50 PERCENT TOTAL OXIDES (CALCIUM OXIDE PLUS MAGNESIUM OXIDE). LIMESTONE MUST BE GROUND TO SUCH FINENESS THAT AT LEAST 50 PERCENT WILL PASS THROUGH A #100 MESH SIEVE AND 98 TO 100 PERCENT WILL PASS THROUGH A #200 MESH SIEVE.  
4. LIME AND FERTILIZER ARE TO BE EVENLY DISTRIBUTED AND INCORPORATED INTO THE TOP 3 TO 5 INCHES OF SOIL BY DISKING OR OTHER SUITABLE MEANS.  
5. WHERE THE SUBSOIL IS EITHER HIGHLY ACIDIC OR COMPOSED OF HEAVY CLAYS, SPREAD GROUND LIMESTONE AT THE RATE OF 4 TO 8 TONS/ACRE (200-400 POUNDS PER 1,000 SQUARE FEET) PRIOR TO THE PLACEMENT OF TOPSOIL.

#### B-4-3 SEEDING AND MULCHING

A. SEEDING  
1. SPECIFICATIONS  
a. ALL SEED MUST MEET THE REQUIREMENTS OF THE MARYLAND STATE SEED LAW. ALL SEED MUST BE SUBJECT TO RE-TESTING BY A RECOGNIZED SEED LABORATORY. ALL SEED USED MUST HAVE BEEN TESTED WITHIN THE 6 MONTHS IMMEDIATELY PRECEDING THE DATE OF SOWING SUCH MATERIAL ON ANY PROJECT. REFER TO TABLE A REGARDING THE QUALITY OF SEED. SEED TAGS MUST BE AVAILABLE UPON REQUEST TO THE INSPECTOR FOR TO VERIFY TYPE AND RATE OF SEED USED.  
b. MULCH ALONE MAY BE APPLIED BETWEEN THE FALL AND SPRING SEEDING DATES ONLY IF THE GROUND IS FROZEN. THE APPROPRIATE SEEDING MIXTURE MUST BE APPLIED WHEN THE GROUND THAWS.  
c. INOCULANTS: THE INOCULANT FOR TREATING LEGUME SEED IN THE SEED MIXTURES MUST BE A PURE CULTURE OF NITROGEN FIXING BACTERIA PREPARED SPECIFICALLY FOR THE SPECIES. INOCULANTS MUST NOT BE USED LATER THAN THE DATE INDICATED ON THE CONTAINER. ADD FRESH INOCULANTS AS DIRECTED ON THE PACKAGE. USE FOUR TIMES THE RECOMMENDED RATE WHEN HYDROSEEDING. NOTE: IT IS VERY IMPORTANT TO KEEP INOCULANTS AS COOL AS POSSIBLE UNTIL USED. TEMPERATURES ABOVE 75 TO 80 DEGREES FAHRENHEIT CAN WEAKEN BACTERIA AND MAKE THE INOCULANT LESS EFFECTIVE.  
d. SOD OR SEED MUST BE PLACED ON SOIL WHICH HAS BEEN TREATED WITH SOIL STERILANTS OR CHEMICALS USED FOR WEED CONTROL UNTIL SUFFICIENT TIME HAS ELAPSED (14 DAYS MIN.) TO PERMIT DISSIPATION OF PHYTO-TOXIC MATERIALS.  
2. APPLICATION  
a. DRY SEEDING: THIS INCLUDES USE OF CONVENTIONAL DROP OR BROADCAST SPREADERS.  
i. INCORPORATE SEED INTO THE SUBSOIL AT THE RATES PRESCRIBED ON TEMPORARY SEEDING TABLE B.1, PERMANENT SEEDING TABLE B.3, OR SITE-SPECIFIC SEEDING SUMMARIES.  
ii. APPLY SEED IN TWO DIRECTIONS, PERPENDICULAR TO EACH OTHER. APPLY HALF THE SEEDING RATE IN EACH DIRECTION. ROLL THE SEEDED AREA WITH A WEIGHTED ROLLER TO PROVIDE GOOD SEED TO SOIL CONTACT.  
b. DRILL OR CULTIPACKER SEEDING: MECHANIZED SEEDERS THAT APPLY AND COVER SEED WITH SOIL.  
i. TRACKPACING SEEDERS ARE REQUIRED TO BURY THE SEED IN SUCH A FASHION AS TO PROVIDE AT LEAST 1/4 INCH OF SOIL COVERING. SEEDS MUST BE FIRM AFTER PLANTING.  
ii. APPLY SEED IN TWO DIRECTIONS, PERPENDICULAR TO EACH OTHER. APPLY HALF THE SEEDING RATE IN EACH DIRECTION.  
c. HYDROSEEDING: APPLY SEED UNIFORMLY WITH HYDROSEEDER (SLURRY INCLUDES SEED AND FERTILIZER).  
i. IF FERTILIZER IS BEING APPLIED AT THE TIME OF SEEDING, THE APPLICATION RATES SHOULD NOT EXCEED THE FOLLOWING: NITROGEN, 100 POUNDS PER ACRE TOTAL OF SOLUBLE NITROGEN, P205 (PHOSPHOROUS), 200 POUNDS PER ACRE; K2O (POTASSIUM), 200 POUNDS PER ACRE.  
ii. LIME: USE ONLY GROUND AGRICULTURAL LIMESTONE (UP TO 3 TONS PER ACRE MAY BE APPLIED BY HYDROSEEDING). NORMALLY, NOT MORE THAN 2 TONS ARE APPLIED BY HYDROSEEDING AT ANY ONE TIME. DO NOT USE BURNT OR HYDRATED LIME WHEN HYDROSEEDING.  
iii. MIX SEED AND FERTILIZER ON SITE AND SEED IMMEDIATELY AND WITHOUT INTERRUPTION.  
iv. WHEN HYDROSEEDING DO NOT INCORPORATE SEED INTO THE SOIL.  
B. MULCHING  
1. MULCH MATERIALS (IN ORDER OF PREFERENCE)  
a. STRAW CONSISTING OF THOROUGHLY THRESHED WHEAT, RYE, OAT, OR BARLEY AND REASONABLY BRIGHT IN COLOR. STRAW IS TO BE FREE OF NOXIOUS WEED SEEDS AS SPECIFIED IN THE MARYLAND SEED LAW AND NOT MUSTY, MOLLY, CAKED, DECAYED, OR EXCESSIVELY DUSTY. NOTE: USE ONLY STERILE STRAW MULCH IN AREAS WHERE ONE SPECIES OF GRASS IS DESIRED.  
b. WOOD CELLULOSE FIBER MULCH (WCFM) CONSISTING OF SPECIALLY PREPARED WOOD CELLULOSE PROCESSED INTO A UNIFORM FIBROUS PHYSICAL STATE.  
i. WCFM IS TO BE DYED GREEN OR CONTAIN A GREEN DYE IN THE PACKAGE THAT WILL PROVIDE AN APPROPRIATE COLOR TO FACILITATE VISUAL INSPECTION OF THE UNIFORMITY OF SPREAD SLURRY.  
ii. WCFM, INCLUDING DYE, MUST CONTAIN NO GERMINATION OR GROWTH INHIBITING FACTORS.  
iii. WCFM MATERIALS ARE TO BE MANUFACTURED AND PROCESSED IN SUCH A MANNER THAT THE WOOD CELLULOSE FIBER MULCH WILL REMAIN IN UNIFORM SUSPENSION IN WATER UNDER AGITATION AND WILL BLEND WITH SEED, FERTILIZER AND OTHER ADDITIVES TO FORM A HOMOGENEOUS SLURRY. THE MULCH MATERIAL MUST FORM A BLOTTER-LIKE GROUND COVER, ON APPLICATION, HAVING MOISTURE ABSORPTION AND PERCOLATION PROPERTIES AND MUST COVER AND HOLD GRASS SEED IN CONTACT WITH THE SOIL WITHOUT INHIBITING THE GROWTH OF THE GRASS SEEDLINGS.  
iv. WCFM MATERIAL MUST NOT CONTAIN ELEMENTS OR COMPOUNDS AT CONCENTRATION LEVELS THAT WILL BE PHYTO-TOXIC.  
v. WCFM MUST CONFORM TO THE FOLLOWING PHYSICAL REQUIREMENTS: FIBER LENGTH OF APPROXIMATELY 10 MILLIMETERS, DIAMETER APPROXIMATELY 1 MILLIMETER, PH RANGE OF 4.0 TO 8.5, ASH CONTENT OF 1.6 PERCENT MAXIMUM AND WATER HOLDING CAPACITY OF 90 PERCENT MINIMUM.  
2. APPLICATION  
a. APPLY MULCH TO ALL SEEDED AREAS IMMEDIATELY AFTER SEEDING.  
b. WHEN STRAW MULCH IS USED, SPREAD IT OVER ALL SEEDED AREAS AT THE RATE OF 2 TONS PER ACRE TO A UNIFORM LOOSE DEPTH OF 1 TO 2 INCHES. APPLY MULCH TO ACHIEVE A UNIFORM DISTRIBUTION AND DEPTH SO THAT THE SOIL SURFACE IS NOT EXPOSED. WHEN USING A MULCH ANCHORING TOOL, INCREASE THE APPLICATION RATE TO 2.5 TONS PER ACRE.  
c. WOOD CELLULOSE FIBER USED AS MULCH MUST BE APPLIED AT A NET DRY WEIGHT OF 1500 POUNDS PER ACRE. MIX THE WOOD CELLULOSE FIBER WITH WATER TO ATTAIN A MIXTURE WITH A MAXIMUM OF 50 POUNDS OF WOOD CELLULOSE FIBER PER 100 GALLONS OF WATER.  
3. ANCHORING  
a. PERFORM MULCH ANCHORING IMMEDIATELY FOLLOWING APPLICATION TO MINIMIZE LOSS BY WIND OR WATER. THIS MAY BE DONE BY ONE OF THE FOLLOWING METHODS (LISTED BY PREFERENCE), DEPENDING UPON THE SIZE OF THE AREA AND EROSION HAZARD.  
i. A MULCH ANCHORING TOOL IS A TRACTOR DRAWN IMPLEMENT DESIGNED TO PUNCH AND ANCHOR MULCH INTO THE SOIL SURFACE A MINIMUM OF 2 INCHES. THIS PRACTICE IS MOST EFFECTIVE ON LARGE AREAS, BUT IS LIMITED TO FLATTER SLOPES WHERE EQUIPMENT CAN OPERATE SAFELY. IF USED ON SLOPING LAND, THIS PRACTICE SHOULD BE USED ON THE CONTOUR IF POSSIBLE.  
ii. WOOD CELLULOSE FIBER MAY BE USED FOR ANCHORING STRAW. APPLY THE FIBER BINDER AT A NET DRY WEIGHT OF 750 POUNDS PER ACRE. MIX THE WOOD CELLULOSE FIBER WITH WATER AT A MAXIMUM OF 50 POUNDS OF WOOD CELLULOSE FIBER PER 100 GALLONS OF WATER.  
iii. SYNTHETIC BINDERS SUCH AS ACRYLIC DLR (AGRO-TACK), DCA-70, PETROSET, TERRA TAXI, TERRA TACK AR OR OTHER APPROVED EQUAL MAY BE USED. FOLLOW APPLICATION RATES AS SPECIFIED BY THE MANUFACTURER. APPLICATION OF LIQUID BINDERS NEEDS TO BE HEAVIER AT THE EDGES WHERE WIND CATCHES MULCH, SUCH AS IN VALLEYS AND ON CRESTS OF BANKS. USE OF ASPHALT BINDERS IS STRICTLY PROHIBITED.  
iv. LIGHTWEIGHT PLASTIC NETTING MAY BE STAPLED OVER THE MULCH ACCORDING TO MANUFACTURER RECOMMENDATIONS. NETTING IS USUALLY AVAILABLE IN ROLLS 4 TO 15 FEET WIDE AND 300 TO 3,000 FEET LONG.

#### B-4-4 TEMPORARY STABILIZATION

**CONDITIONS WHERE PRACTICE APPLIES**  
EXPOSED SOILS WHERE GROUND COVER IS NEEDED FOR A PERIOD OF 6 MONTHS OR LESS. FOR LONGER DURATION OF TIME, PERMANENT STABILIZATION PRACTICES ARE REQUIRED.

#### CRITERIA

- SELECT ONE OR MORE OF THE SPECIES OR SEED MIXTURES LISTED IN TABLE B.1 FOR THE APPROPRIATE PLANT HARDINESS ZONE (FROM FIGURE B.3), AND ENTER SEEDING SUMMARY BELOW ALONG WITH APPLICATION RATES, SEEDING DATES AND SEEDING DEPTHS. IF THIS SUMMARY IS NOT PUT ON THE PLAN AND COMPLETED, THEN TABLE B.1 PLUS FERTILIZER AND LIME RATES MUST BE PUT ON THE PLAN.
- FOR SITES HAVING SOIL TESTS PERFORMED, USE AND SHOW THE RECOMMENDED RATES BY THE TESTING AGENCY. SOIL TESTS ARE NOT REQUIRED FOR TEMPORARY SEEDING.
- WHEN STABILIZATION IS REQUIRED OUTSIDE OF A SEEDING SEASON, APPLY SEED AND MULCH OR STRAW MULCH ALONE AS PRESCRIBED IN SECTION B-4-3-A.1.b AND MAINTAIN UNTIL THE NEXT SEEDING SEASON.

#### TEMPORARY SEEDING SUMMARY

Seed Mixture (Hardiness Zone 7a)				Fertilizer Rate (10-20-20)		Lime Rate
Species	Application Rate	Seeding Dates	Depths	N	P205	
ANNUAL RYEGRASS	40 lb/ac 25 lb/ac 5 lb/cw	2/15 - 4/30 8/15 - 11/30	1/2"	43 lb/ac (10 lb/ac)	90 lb/ac (22.0 lb/ac)	2 tons/ac (500 lb/ac)
FOXTAIL MILLET	30 lb/ac	5/1 - 8/14	1/2"			

NOTE TO CONTRACTOR: SEDIMENT AND EROSION CONTROL SHALL BE STRICTLY ENFORCED.

#### B-4-5 PERMANENT STABILIZATION

**CONDITIONS WHERE PRACTICE APPLIES**  
EXPOSED SOILS WHERE GROUND COVER IS NEEDED FOR 6 MONTHS OR MORE.

#### A. SEED MIXTURES

- GENERAL USE  
a. SELECT ONE OR MORE OF THE SPECIES OR MIXTURES LISTED IN TABLE B.3 FOR THE APPROPRIATE PLANT HARDINESS ZONE (FROM FIGURE B.3), AND BASED ON THE SITE CONDITION OR PURPOSE (FROM TABLE B.2 ENTER SELECTED MIXTURE(S), APPLICATION RATES, AND SEEDING DATES IN THE PERMANENT SEEDING SUMMARY. THE SUMMARY IS TO BE PLACED ON THE PLAN.  
b. ADDITIONAL PLANTING SPECIFICATIONS FOR EXCEPTIONAL SITES SUCH AS SHORELINES, STREAM BANKS, OR DUNES OR FOR SPECIAL PURPOSES SUCH AS WILDLIFE OR AESTHETIC TREATMENT MAY BE FOUND IN USDA-NRCS TECHNICAL FIELD OFFICE GUIDE, SECTION 342-CRITICAL AREA PLANTING.  
c. FOR SITES HAVING DISTURBED AREA OVER 5 ACRES, USE AND SHOW THE RATES RECOMMENDED BY THE SOIL TESTING AGENCY.  
d. FOR AREAS RECEIVING LOW MAINTENANCE, APPLY UREA FORM FERTILIZER (46-0-0) AT 3 1/2 POUNDS PER 1000 SQUARE FEET (150 POUNDS PER ACRE) AT THE TIME OF SEEDING IN ADDITION TO THE SOIL AMENDMENTS SHOWN IN THE PERMANENT SEEDING SUMMARY.  
2. TURFGRASS MIXTURES  
a. AREAS WHERE TURFGRASS MAY BE DESIRED INCLUDE LAWNS, PARKS, PLAYGROUNDS, AND COMMERCIAL SITES WHICH WILL RECEIVE A MEDIUM TO HIGH LEVEL OF MAINTENANCE.  
b. SELECT ONE OR MORE OF THE SPECIES OR MIXTURES LISTED BELOW BASED ON THE SITE CONDITIONS OR PURPOSE. ENTER SELECTED MIXTURE(S), APPLICATION RATES, AND SEEDING DATES IN THE PERMANENT SEEDING SUMMARY. THE SUMMARY IS TO BE PLACED ON THE PLAN.  
i. KENTUCKY BLUEGRASS: FULL SUN MIXTURE. FOR USE IN AREAS THAT RECEIVE INTENSIVE MANAGEMENT. IRRIGATION REQUIRED IN THE AREAS OF CENTRAL MARYLAND AND EASTERN SHORE. RECOMMENDED CERTIFIED KENTUCKY BLUEGRASS CULTIVARS SEEDING RATE: 15 TO 20 POUNDS PER 1000 SQUARE FEET. CHOOSE A MINIMUM OF THREE KENTUCKY BLUEGRASS CULTIVARS WITH EACH RANGING FROM 10 TO 35 PERCENT OF THE TOTAL MIXTURE BY WEIGHT.  
ii. KENTUCKY BLUEGRASS/PERENNIAL RYE: FULL SUN MIXTURE. FOR USE IN FULL SUN AREAS WHERE RAPID ESTABLISHMENT IS NECESSARY AND WHEN TURF WILL RECEIVE MEDIUM TO INTENSIVE MANAGEMENT. CERTIFIED PERENNIAL RYEGRASS CULTIVARS/CERTIFIED KENTUCKY BLUEGRASS SEEDING RATE: 2 POUNDS MIXTURE PER 1000 SQUARE FEET. CHOOSE A MINIMUM OF THREE KENTUCKY BLUEGRASS CULTIVARS WITH EACH RANGING FROM 10 TO 35 PERCENT OF THE TOTAL MIXTURE BY WEIGHT.  
iii. TALL FESCUE/KENTUCKY BLUEGRASS: FULL SUN MIXTURE. FOR USE IN DROUGHT PRONE AREAS AND/OR FOR AREAS RECEIVING LOW TO MEDIUM MANAGEMENT IN FULL SUN TO MEDIUM SHADE. RECOMMENDED MIXTURE INCLUDES: CERTIFIED TALL FESCUE CULTIVARS 25 TO 100 PERCENT, CERTIFIED KENTUCKY BLUEGRASS CULTIVARS 0 TO 5 PERCENT. SEEDING RATE: 5 TO 8 POUNDS PER 1000 SQUARE FEET. ONE OR MORE CULTIVARS MAY BE BLENDED.  
iv. KENTUCKY BLUEGRASS/FINE FESCUE: SHADE MIXTURE. FOR USE IN AREAS WITH SHADE IN BLUEGRASS LAWNS. FOR ESTABLISHMENT IN HIGH QUALITY, INTENSIVELY MANAGED TURF AREA MIXTURE INCLUDES: CERTIFIED KENTUCKY BLUEGRASS CULTIVARS 30 TO 40 PERCENT AND CERTIFIED FINE FESCUE AND 60 TO 70 PERCENT. SEEDING RATE: 1 1/2 TO 3 POUNDS PER 1000 SQUARE FEET.  
**NOTES:**  
TURFGRASS VARIETIES SHOULD BE SELECTED FROM THOSE LISTED IN THE MOST CURRENT UNIVERSITY OF MARYLAND PUBLICATION, AGRONOMY MEMO #77, "TURFGRASS CULTURAL RECOMMENDATIONS FOR MARYLAND".

CHOOSE CERTIFIED MATERIAL. CERTIFIED MATERIAL IS THE BEST GUARANTEE OF CULTIVAR PURITY. THE CERTIFICATION PROGRAM OF THE MARYLAND DEPARTMENT OF AGRICULTURE, TURF AND SEED SECTION, PROVIDES A RELIABLE MEANS OF CONSUMER PROTECTION AND ASSURES A PURE GENETIC LINE.

- IDEAL TIMES OF SEEDING  
WESTERN MD: MARCH 15 TO JUNE 1, AUGUST 1 TO OCTOBER 1 (HARDINESS ZONES: 6B, 6A)  
CENTRAL MD: MARCH 1 TO MAY 15, AUGUST 15 TO OCTOBER 15 (HARDINESS ZONES: 7A, 7B)  
SOUTHERN MD, EASTERN SHORE: MARCH 1 TO MAY 15, AUGUST 15 TO OCTOBER 15 (HARDINESS ZONES: 7A, 7B)  
d. TILL AREAS TO RECEIVE SEED BY DISKING OR OTHER APPROVED METHODS TO A DEPTH OF 2 TO 4 INCHES. LEVEL AND RAKE THE AREAS TO PREPARE A PROPER SEEDBED. REMOVE STONES AND DEBRIS OVER 1/4 INCHES IN DIAMETER. THE RESULTING SEEDBED MUST BE IN SUCH CONDITION THAT FUTURE MOWING OF GRASSES WILL POSE NO DIFFICULTY.  
e. IF SOIL MOISTURE IS SUFFICIENT, SUPPLY NEW SEEDINGS WITH ADEQUATE WATER FOR PLANT GROWTH (1/4 TO 1 INCH EVERY 3 TO 4 DAYS DEPENDING ON SOIL TEXTURE) UNTIL THEY ARE FIRMLY ESTABLISHED. THIS IS ESPECIALLY TRUE WHEN SEEDINGS ARE MADE LATE IN THE PLANTING SEASON, IN ABNORMALLY DRY OR HOT SEASONS, OR ON ADVERSE SITES.

#### PERMANENT SEEDING SUMMARY

Seed Mixture (Hardiness Zone 7a)					Fertilizer Rate (10-20-20)			Lime Rate
Mix No.	Species	Application Rate	*Seeding Dates	Seeding Depth	N	P205	K20	
6	TALL FESCUE PERENNIAL RYE GRASS WHITE CLOVER	40 lb/ac 25 lb/ac 5 lb/cw						
7	CREeping RED FESCUE KENTUCKY BLUEGRASS	60 lb/ac 15 lb/ac	2/15 - 4/30 8/15 - 10/31	1/4"-1/2"	45 lb/ac (1 lb/ac)	90 lb/ac (2.0 lb/ac)	90 lb/ac (2.0 lb/ac)	2 tons/ac (90 lb/ac)
11	CREeping RED FESCUE CHEWINGS FESCUE KENTUCKY BLUEGRASS ROUGH BLUEGRASS	30 lb/ac 30 lb/ac 20 lb/ac 15 lb/ac						

\*FOR THE PERIOD 5/1 - 8/14 ADD FOXTAIL OR PEARL MILLET TO THE PERMANENT SEED MIX. DO NOT EXCEED MORE THAN 5% (BY WEIGHT) OF THE OVERALL PERMANENT SEEDING MIX.

#### B. SOD

- TO PROVIDE QUICK COVER ON DISTURBED AREAS (2:1 GRADE OR FLATTER).  
1. GENERAL SPECIFICATIONS  
a. CLASS OF TURFGRASS SOD MUST BE MARYLAND STATE CERTIFIED. SOD LABELS MUST BE MADE AVAILABLE TO THE JOB FOREMAN AND INSPECTOR.  
b. SOD MUST BE MACHINE CUT AT A UNIFORM SOIL THICKNESS OF 1/4 INCH, PLUS OR MINUS 1/8 INCH, AT THE TIME OF CUTTING. MEASUREMENT FOR THICKNESS MUST EXCLUDE TOP GROWTH AND THATCH. BROKEN PADS AND TORN OR UNFURN ENDS WILL NOT BE ACCEPTABLE.  
c. STANDARD SIZE SECTIONS OF SOD MUST BE STRONG ENOUGH TO SUPPORT THEIR OWN WEIGHT AND RETAIN THEIR SIZE AND SHAPE WHEN SUSPENDED VERTICALLY WITH A FIRM GRASP ON THE UPPER 10 PERCENT OF THE SECTION.  
d. SOD MUST NOT BE HARVESTED OR TRANSPLANTED WHEN MOISTURE CONTENT (EXCESSIVELY DRY OR WET) MAY ADVERSELY AFFECT ITS SURVIVAL.  
e. SOD MUST BE HARVESTED, DELIVERED, AND INSTALLED WITHIN A PERIOD OF 36 HOURS. SOD NOT TRANSPLANTED WITHIN THIS PERIOD MUST BE APPROVED BY AN AGRONOMIST OR SOIL SCIENTIST PRIOR TO ITS INSTALLATION.  
2. SOD INSTALLATION  
a. DURING PERIODS OF EXCESSIVELY HIGH TEMPERATURE OR IN AREAS HAVING DRY SUBSOIL, LIGHTLY IRRIGATE THE SUBSOIL IMMEDIATELY PRIOR TO LAYING THE SOD.  
b. LAY THE FIRST ROW OF SOD IN A STRAIGHT LINE WITH SUBSEQUENT ROWS PLACED PARALLEL TO IT AND TIGHTLY WEDGED AGAINST EACH OTHER. STAGGER LATERAL JOINTS TO PROMOTE MORE UNIFORM GROWTH AND STRENGTH. ENSURE THAT SOD IS NOT STRETCHED OR OVERLAPPED AND THAT ALL JOINTS ARE BUTTED TIGHT IN ORDER TO PREVENT VOIDS WHICH WOULD CAUSE AIR DRYING OF THE ROOTS.  
c. WHEREVER POSSIBLE, LAY SOD WITH THE LONG EDGES PARALLEL TO THE CONTOUR AND WITH STAGGERING JOINTS. ROLL AND TAMP, PEG OR OTHERWISE SECURE THE SOD TO PREVENT SLIPPAGE ON SLOPES. ENSURE SOD CONTACT EXISTS BETWEEN SOD ROOTS AND THE UNDERLYING SOIL SURFACE.  
d. WATER THE SOD IMMEDIATELY FOLLOWING ROLLING AND TAMPING UNTIL THE UNDERSIDE OF THE NEW SOD PAD AND SOIL SURFACE BELOW THE SOD ARE THOROUGHLY WET. COMPLETE THE OPERATIONS OF LAYING, TAMPING AND IRRIGATING FOR ANY PIECE OF SOD WITHIN EIGHT HOURS.  
3. SOD MAINTENANCE  
a. IN THE ABSENCE OF ADEQUATE RAINFALL, WATER DAILY DURING THE FIRST WEEK OR AS OFTEN AND SUFFICIENTLY AS NECESSARY TO MAINTAIN MOIST SOIL TO A DEPTH OF 4 INCHES. WATER SOD DURING THE HEAT OF THE DAY TO PREVENT WILTING.  
b. AFTER THE FIRST WEEK, SOD WATERING IS REQUIRED AS NECESSARY TO MAINTAIN ADEQUATE MOISTURE CONTENT.  
c. DO NOT MOW UNTIL THE SOD IS FIRMLY ROOTED. NO MORE THAN 1/4 OF THE GRASS LEAF MUST BE REMOVED BY THE INITIAL CUTTING OR SUBSEQUENT CUTTINGS. MAINTAIN GRASS HEIGHT AT LEAST 3 INCHES UNLESS OTHERWISE SPECIFIED.

#### OWNER

PROPERTY MANAGEMENT, CAPITAL SERVICES  
12200 LONG GREEN PIKE  
GLEN ARM, MD 21057  
MICHAEL GOODYEAR  
SITE ADDRESS:  
323 SOLLERS POINT RD, DUNDALK, MD 21222

COORDINATES SHOWN HEREON ARE REFERRED TO THE MARYLAND STATE PLANE COORDINATE SYSTEM, NAD 83 (1981). ELEVATIONS SHOWN HEREON ARE REFERRED TO THE NORTH AMERICAN VERTICAL DATUM OF 1988 (NAVD 88).

SIGNATURE OF OWNER/DEVELOPER: *A M Lamm* TITLE: *Facilities Chief* DATE: *8/31/2021*

BALTIMORE COUNTY OFFICE OF BUDGET AND FINANCE, PROPERTY MANAGEMENT  
FIELD, TRACK, AND DRAINAGE REPLACEMENT  
EROSION AND SEDIMENT CONTROL NOTES  
SOLLERS POINT MULTIPURPOSE CENTER  
323 SOLLERS POINT RD.  
DUNDALK, MD 21222

Baltimore County Soil Conservation District  
APPROVED FOR SEDIMENT CONTROL  
*Jeffrey E. W...* 9-4-21 Date

COUNCILMATIC DISTRICT: 7  
CONGRESSIONAL DISTRICT: 2  
LEGISLATIVE DISTRICT: 6  
COUNCILMAN DIST. NO.: 02  
ELECTION DIST. NO.: 12c7

#### OWNER


PROPERTY MANAGEMENT, CAPITAL SERVICES  
12200 LONG GREEN PIKE  
GLEN ARM, MD 21057  
MICHAEL GOODYEAR  
SITE ADDRESS:  
323 SOLLERS POINT RD, DUNDALK, MD 21222

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#### CONTRACT COMPLETION BOX

CONTRACTOR: \_\_\_\_\_  
DATE COMPLETED: \_\_\_\_\_  
INSPECTOR: \_\_\_\_\_  
PIPE MATERIAL (Pressure Only) \_\_\_\_\_

SHEET DESIGNATION	CONTRACT NUMBER
2021-2878	22005 P00
JOB ORDER NUMBER	242-212-307-0472
SHEET 10 OF 15	
DRAWING NUMBER	C502
FILE NO.:	

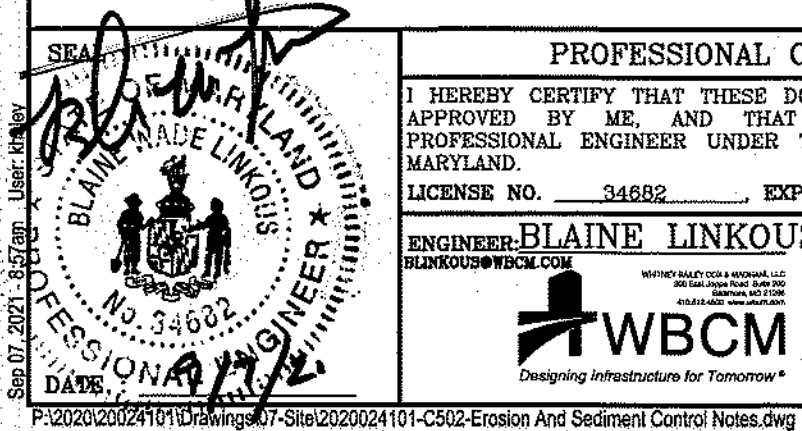

AS-BUILT / REVISION		BY	DATE	P.W.A. NO.	KEY SHEET	POSITION SHT	DRAWING SCALE		DEPARTMENT OF PUBLIC WORKS	
				R.O.W NO.	MNE	37 NE 32 38 NE 32	PLAN SCALE:		APPROVED BY: _____ DIRECTOR	
CONTRACT COMPLETION BOX							PROFILE SCALE:		DATE: _____	
BUREAU OF ENGINEERING AND CONSTRUCTION		TRAFFIC	HIGHWAYS	STRUCTURES	STORM DRAINS	SEWER	WATER	FIELD ENGINEER	HUR. OF ENGINEERING & CONSTRUCTION	
REVIEWED BY:									APPROVED BY: _____ CHIEF	
DATE REVIEWED:									DATE: _____	



H-1 STANDARDS AND SPECIFICATIONS FOR MATERIALS

TABLE H.1: GEOTEXTILE FABRICS

PROPERTY	TEST METHOD	WOVEN SILT FILM GEOTEXTILE		WOVEN MONOFILAMENT GEOTEXTILE		NONWOVEN GEOTEXTILE	
		MD	CD	MD	CD	MD	CD
GRAB TENSILE STRENGTH	ASTM D-4632	200 LB	200 LB	370 LB	250 LB	200 LB	200 LB
GRAB TENSILE ELONGATION	ASTM D-4632	15%	10%	15%	15%	50%	50%
TRAPEZOIDAL TEAR STRENGTH	ASTM D-4533	75 LB	75 LB	100 LB	60 LB	80 LB	80 LB
PUNCTURE STRENGTH	ASTM D-6241	450 LB		900 LB		450 LB	
APPARENT OPENING SIZE <sup>2</sup>	ASTM D-4751	U.S. SIEVE 30 (0.59 MM)		U.S. SIEVE 70 (0.21 MM)		U.S. SIEVE 70 (0.21 MM)	
PERMITTIVITY	ASTM D-4491	0.05 SEC <sup>1</sup>		0.28 SEC <sup>1</sup>		1.1 SEC <sup>1</sup>	
ULTRAVIOLET RESISTANCE RETAINED AT 500 HOURS	ASTM D-4355	70% STRENGTH		70% STRENGTH		70% STRENGTH	

<sup>1</sup> ALL NUMERIC VALUES EXCEPT APPARENT SIZE (AOS) REPRESENT MINIMUM AVERAGE ROLL VALUES (MARV). MARV IS CALCULATED AS THE TYPICAL MINUS TWO STANDARD DEVIATIONS. MD IS MACHINE DIRECTION; CD IS CROSS DIRECTION.

<sup>2</sup> VALUES FOR AOS REPRESENT THE AVERAGE MAXIMUM OPENING.

GEOTEXTILES MUST BE EVALUATED BY THE NATIONAL TRANSPORTATION PRODUCT EVALUATION PROGRAM (NTPPE) AND CONFORM TO THE VALUES IN TABLE H.1.

THE GEOTEXTILE MUST BE INERT TO COMMONLY ENCOUNTERED CHEMICALS AND HYDROCARBONS AND MUST BE ROT AND MILDEW RESISTANT. THE GEOTEXTILE MUST BE MANUFACTURED FROM FIBERS CONSISTING OF LONG CHAIN SYNTHETIC POLYMERS AND COMPOSED OF A MINIMUM OF 95 PERCENT BY WEIGHT OF POLYOLEFINS OR POLYESTERS, AND FORMED INTO A STABLE NETWORK SO THE FILAMENTS OR YARNS RETAIN THEIR DIMENSIONAL STABILITY RELATIVE TO EACH OTHER, INCLUDING SELVAGES.

WHEN MORE THAN ONE SECTION OF GEOTEXTILE IS NECESSARY, OVERLAP THE SECTIONS BY AT LEAST ONE FOOT. THE GEOTEXTILE MUST BE PULLED TAUT OVER THE APPLIED SURFACE. EQUIPMENT MUST NOT RUN OVER EXPOSED FABRIC. WHEN PLACING RIPRAP ON GEOTEXTILE, DO NOT EXCEED A ONE FOOT DROP HEIGHT.

OWNER'S/DEVELOPER'S CERTIFICATION:

"I/WE HEREBY CERTIFY THAT ANY CLEARING, GRADING, CONSTRUCTION AND/OR DEVELOPMENT WILL BE DONE PURSUANT TO THIS PLAN AND THAT ANY RESPONSIBLE PERSONNEL INVOLVED IN THIS CONSTRUCTION WILL HAVE A CERTIFICATE OF ATTENDANCE AT A MARYLAND DEPARTMENT OF THE ENVIRONMENT APPROVED TRAINING PROGRAM FOR THE CONTROL SEDIMENT AND EROSION BEFORE BEGINNING THE PROJECT. I/WE ALSO CERTIFY THAT THE SITE WILL BE INSPECTED AT THE END OF EACH WORKING DAY, AND THAT ANY NEEDED MAINTENANCE WILL BE COMPLETED SO AS TO INSURE THAT ALL SEDIMENT CONTROL PRACTICES ARE LEFT IN OPERATIONAL CONDITION. I/WE AUTHORIZE THE RIGHT OF ENTRY FOR PERIODIC ON-SITE EVALUATION BY THE BALTIMORE COUNTY SOIL CONSERVATION DISTRICT BOARD OF SUPERVISORS OR THEIR AUTHORIZED AGENTS.

*G. M. Doran*

SIGNATURE OWNER/DEVELOPER

0/31/2021

DATE

GREGORY M. DORAN

PRINTED NAME

FACILITIES CHIEF

TITLE

CONSULTANT'S CERTIFICATION:

"I CERTIFY THAT THIS PLAN OF EROSION AND SEDIMENT CONTROL REPRESENTS A PRACTICAL AND WORKABLE PLAN BASED ON MY PERSONAL KNOWLEDGE OF THE SITE, AND THAT THIS PLAN WAS PREPARED IN ACCORDANCE WITH THE REQUIREMENTS OF THE BALTIMORE COUNTY SOIL CONSERVATION DISTRICT AND THE CURRENT STATE OF MARYLAND SPECIFICATIONS FOR SOIL EROSION AND SEDIMENT CONTROL. I HAVE REVIEWED THIS EROSION AND SEDIMENT CONTROL PLAN WITH THE OWNER."

*Blaine W. Linkous*

SIGNATURE

August 31, 2021

DATE

BLAINE W. LINKOUS

PRINT NAME

34682

MD LICENSE NO.

STANDARD STABILIZATION NOTE

FOLLOWING INITIAL SOIL DISTURBANCE OR RE-DISTURBANCE, PERMANENT OR TEMPORARY STABILIZATION SHALL BE COMPLETED WITHIN:

- a.) THREE (3) CALENDAR DAYS AS TO THE SURFACE OF ALL PERIMETER DIKES, SWALES, DITCHES, PERIMETER SLOPES, AND ALL SLOPES GREATER THAN 3 HORIZONTAL TO 1 VERTICAL (3:1); AND
- b.) SEVEN (7) CALENDAR DAYS AS TO ALL OTHER DISTURBED OR GRADED AREAS ON THE PROJECT SITE NOT UNDER ACTIVE GRADING.

OWNER

PROPERTY MANAGEMENT, CAPITAL SERVICES  
12200 LONG GREEN PIKE  
GLEN ARM, MD 21057  
MICHAEL GOODYEAR  
SITE ADDRESS:  
323 SOLLERS POINT RD, DUNDALK, MD 21222

COORDINATES SHOWN HEREON ARE REFERRED TO THE MARYLAND STATE PLANE COORDINATE SYSTEM, NAD 83 (1991). ELEVATIONS SHOWN HEREON ARE REFERRED TO THE NORTH AMERICAN VERTICAL DATUM OF 1988 (NAVD 88).

OWNER

PROPERTY MANAGEMENT, CAPITAL SERVICES  
12200 LONG GREEN PIKE  
GLEN ARM, MD 21057  
BRIAN MCKINLEY  
410-887-2915  
SITE ADDRESS:  
323 SOLLERS POINT RD, DUNDALK, MD 21222

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CONTRACT COMPLETION BOX

CONTRACTOR: \_\_\_\_\_  
DATE COMPLETED: \_\_\_\_\_  
INSPECTOR: \_\_\_\_\_  
PIPE MATERIAL (Pressure Only): \_\_\_\_\_

SHEET DESIGNATION 2021-2879 CONTRACT NUMBER 22005 POO

JOB ORDER NUMBER 242-212-307-0472

SHEET 11 OF 15

DRAWING NUMBER C503

FILE NO.: \_\_\_\_\_

DWG. FILENAME

	PROFESSIONAL CERTIFICATION		AS-BUILT / REVISION	BY	DATE	P.W.A. NO.	KEY SHEET	POSITION SH	DRAWING SCALE	DEPARTMENT OF PUBLIC WORKS
	I HEREBY CERTIFY THAT THESE DOCUMENTS WERE PREPARED OR APPROVED BY ME, AND THAT I AM A DULY LICENSED PROFESSIONAL ENGINEER UNDER THE LAWS OF THE STATE OF MARYLAND.									
	LICENSE NO. 34682 EXPIRATION DATE 07/08/23									
	ENGINEER: BLAINE LINKOUS		DGN BY: K.H.	BUREAU OF ENGINEERING AND CONSTRUCTION	TRAFFIC	HIGHWAYS	STRUCTURES	STORM DRAINS	SEWER	WATER
	DWN BY: H.H.		REVIEWED BY:							
	CHKD BY: B.L.		DATE REVIEWED:							

BALTIMORE COUNTY OFFICE OF BUDGET AND FINANCE, PROPERTY MANAGEMENT

FIELD, TRACK, AND DRAINAGE REPLACEMENT  
EROSION AND SEDIMENT CONTROL NOTES

SOLLERS POINT MULTIPURPOSE CENTER  
323 SOLLERS POINT RD.  
DUNDALK, MD 21222

COUNCILMATIC DISTRICT: 7  
CONGRESSIONAL DISTRICT: 2  
LEGISLATIVE DISTRICT: 6  
COUNCILMAN DIST. NO.: 02





ELECTION DIST. NO.: 12c7

SUBDIVISION: SOLLERS POINT







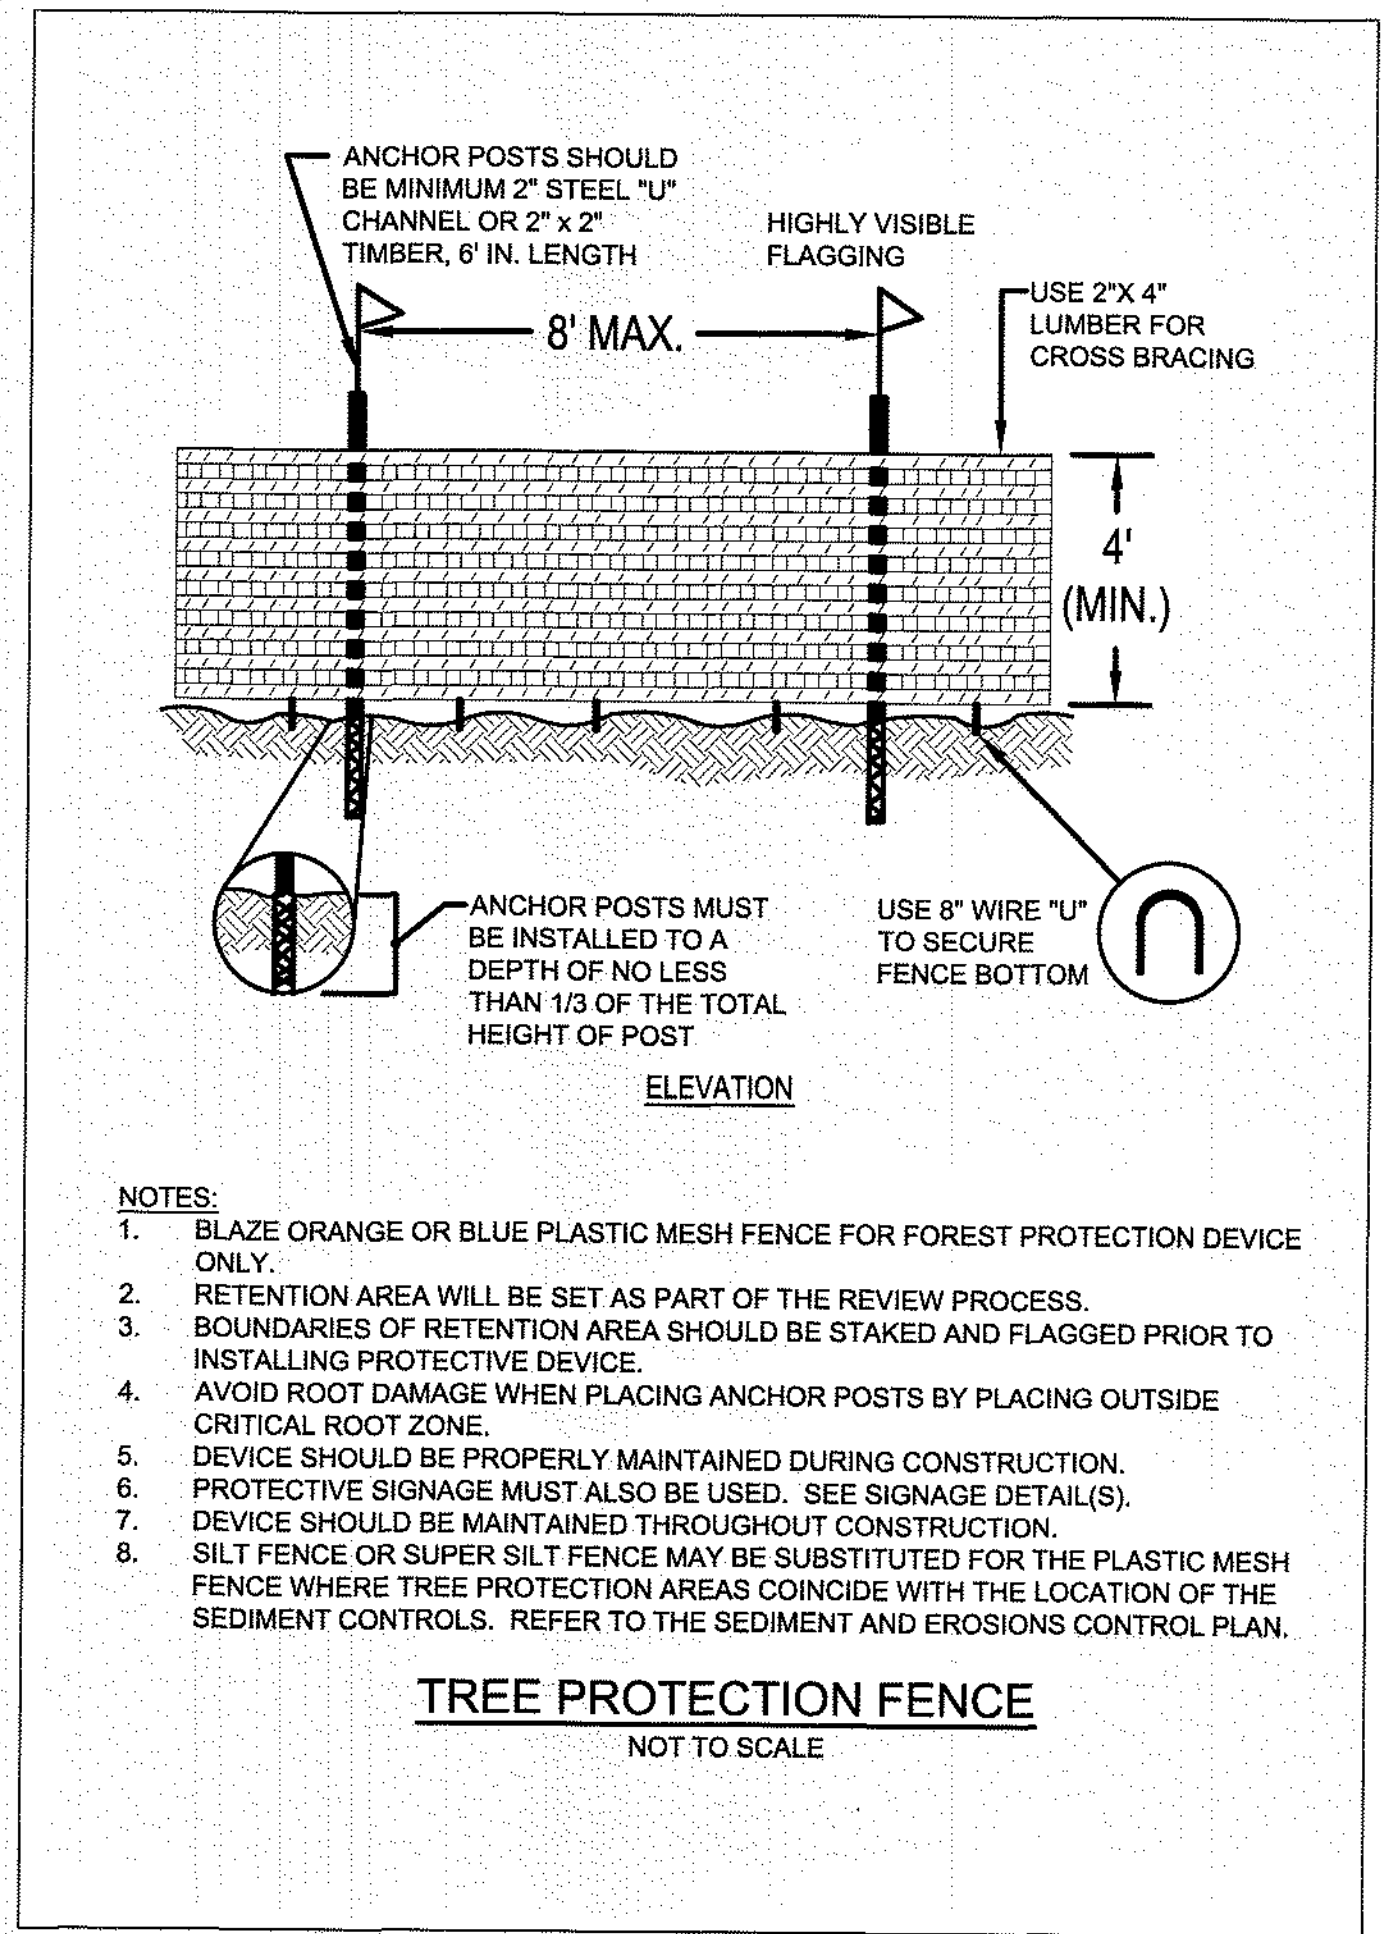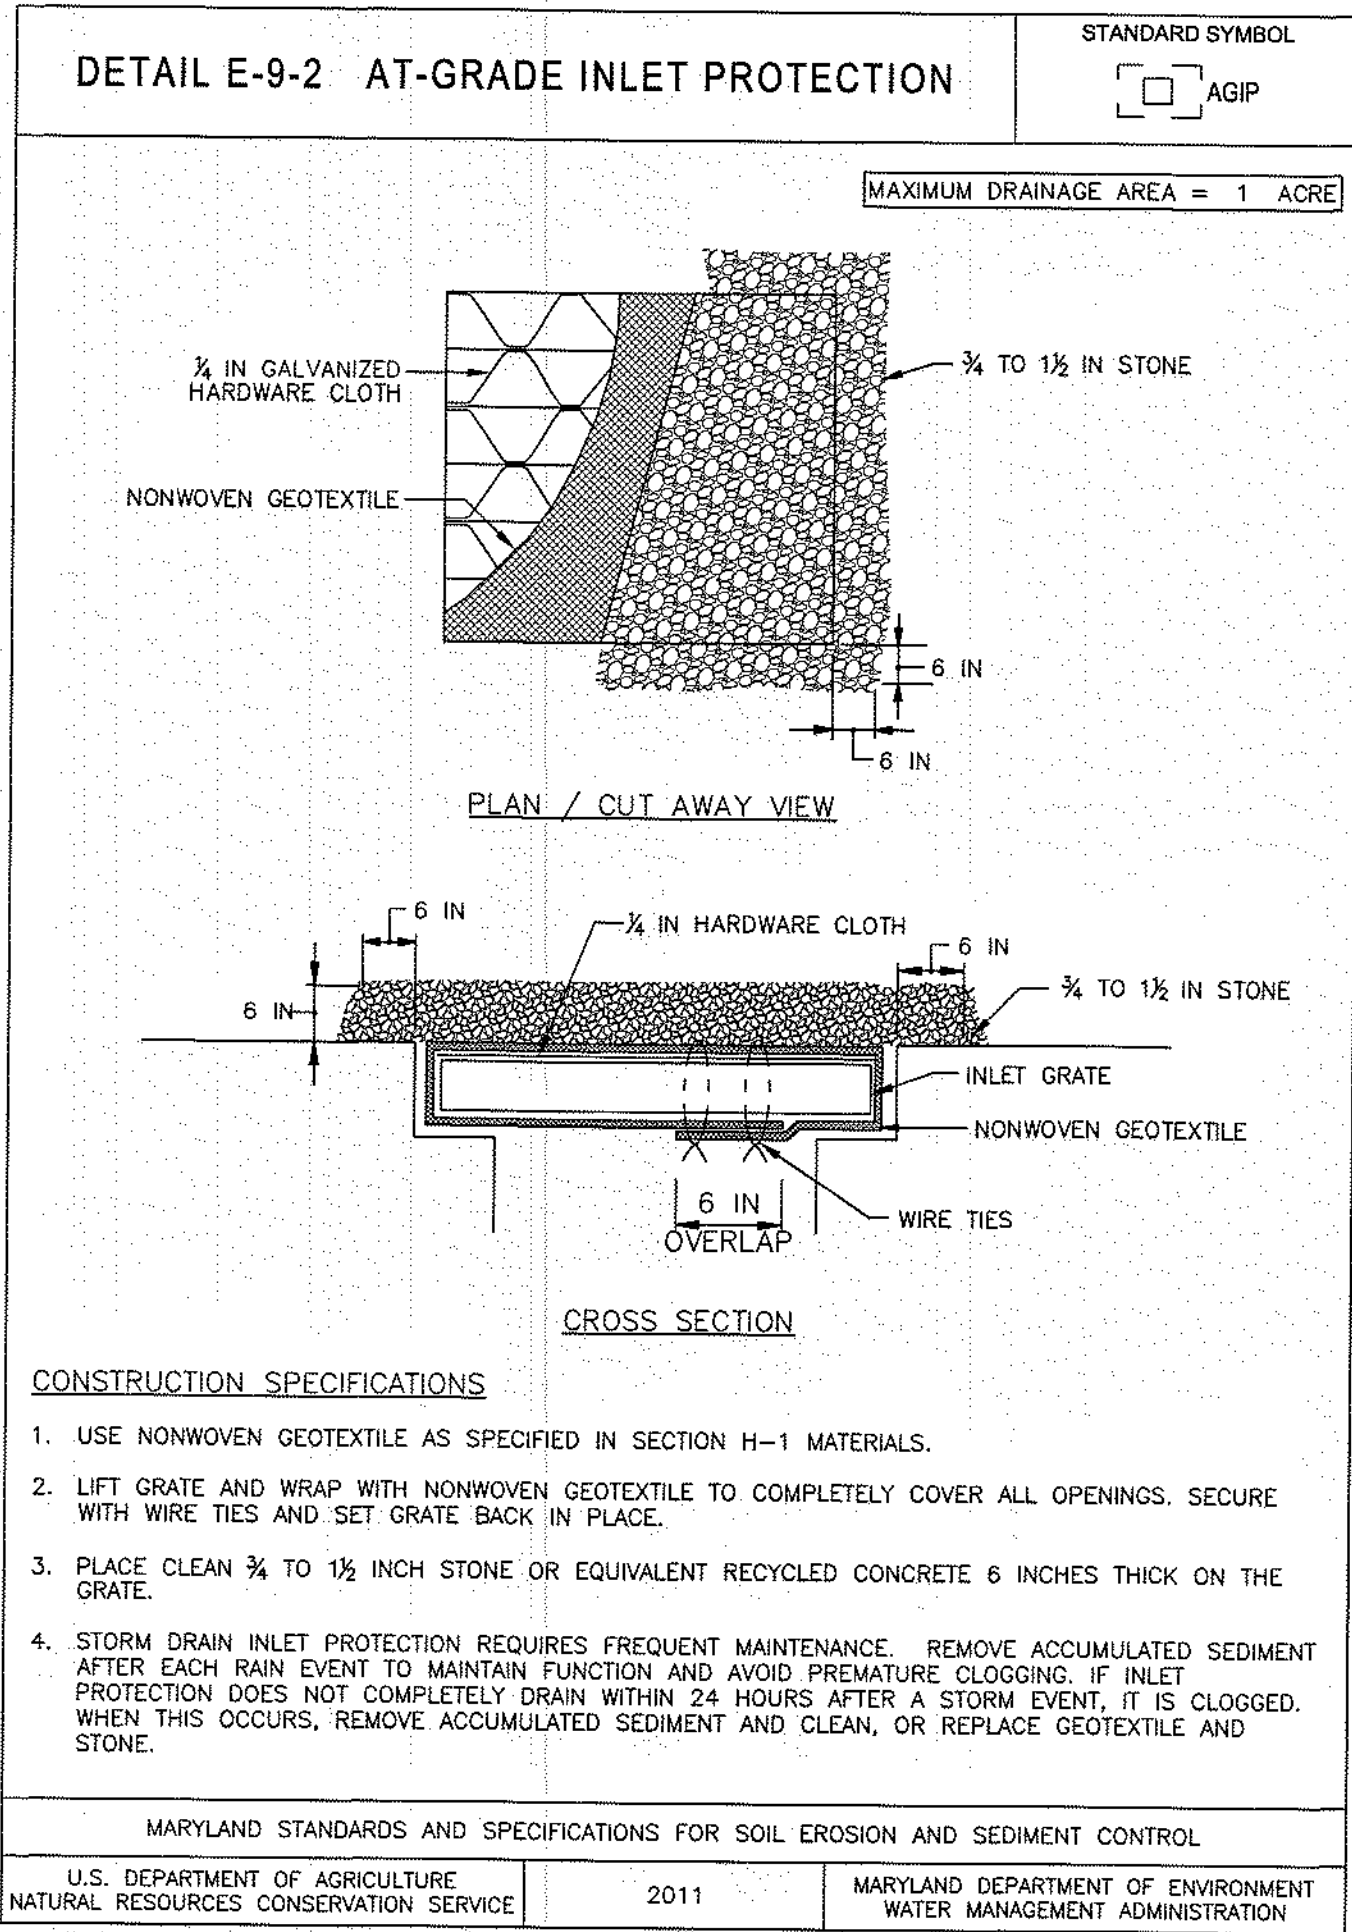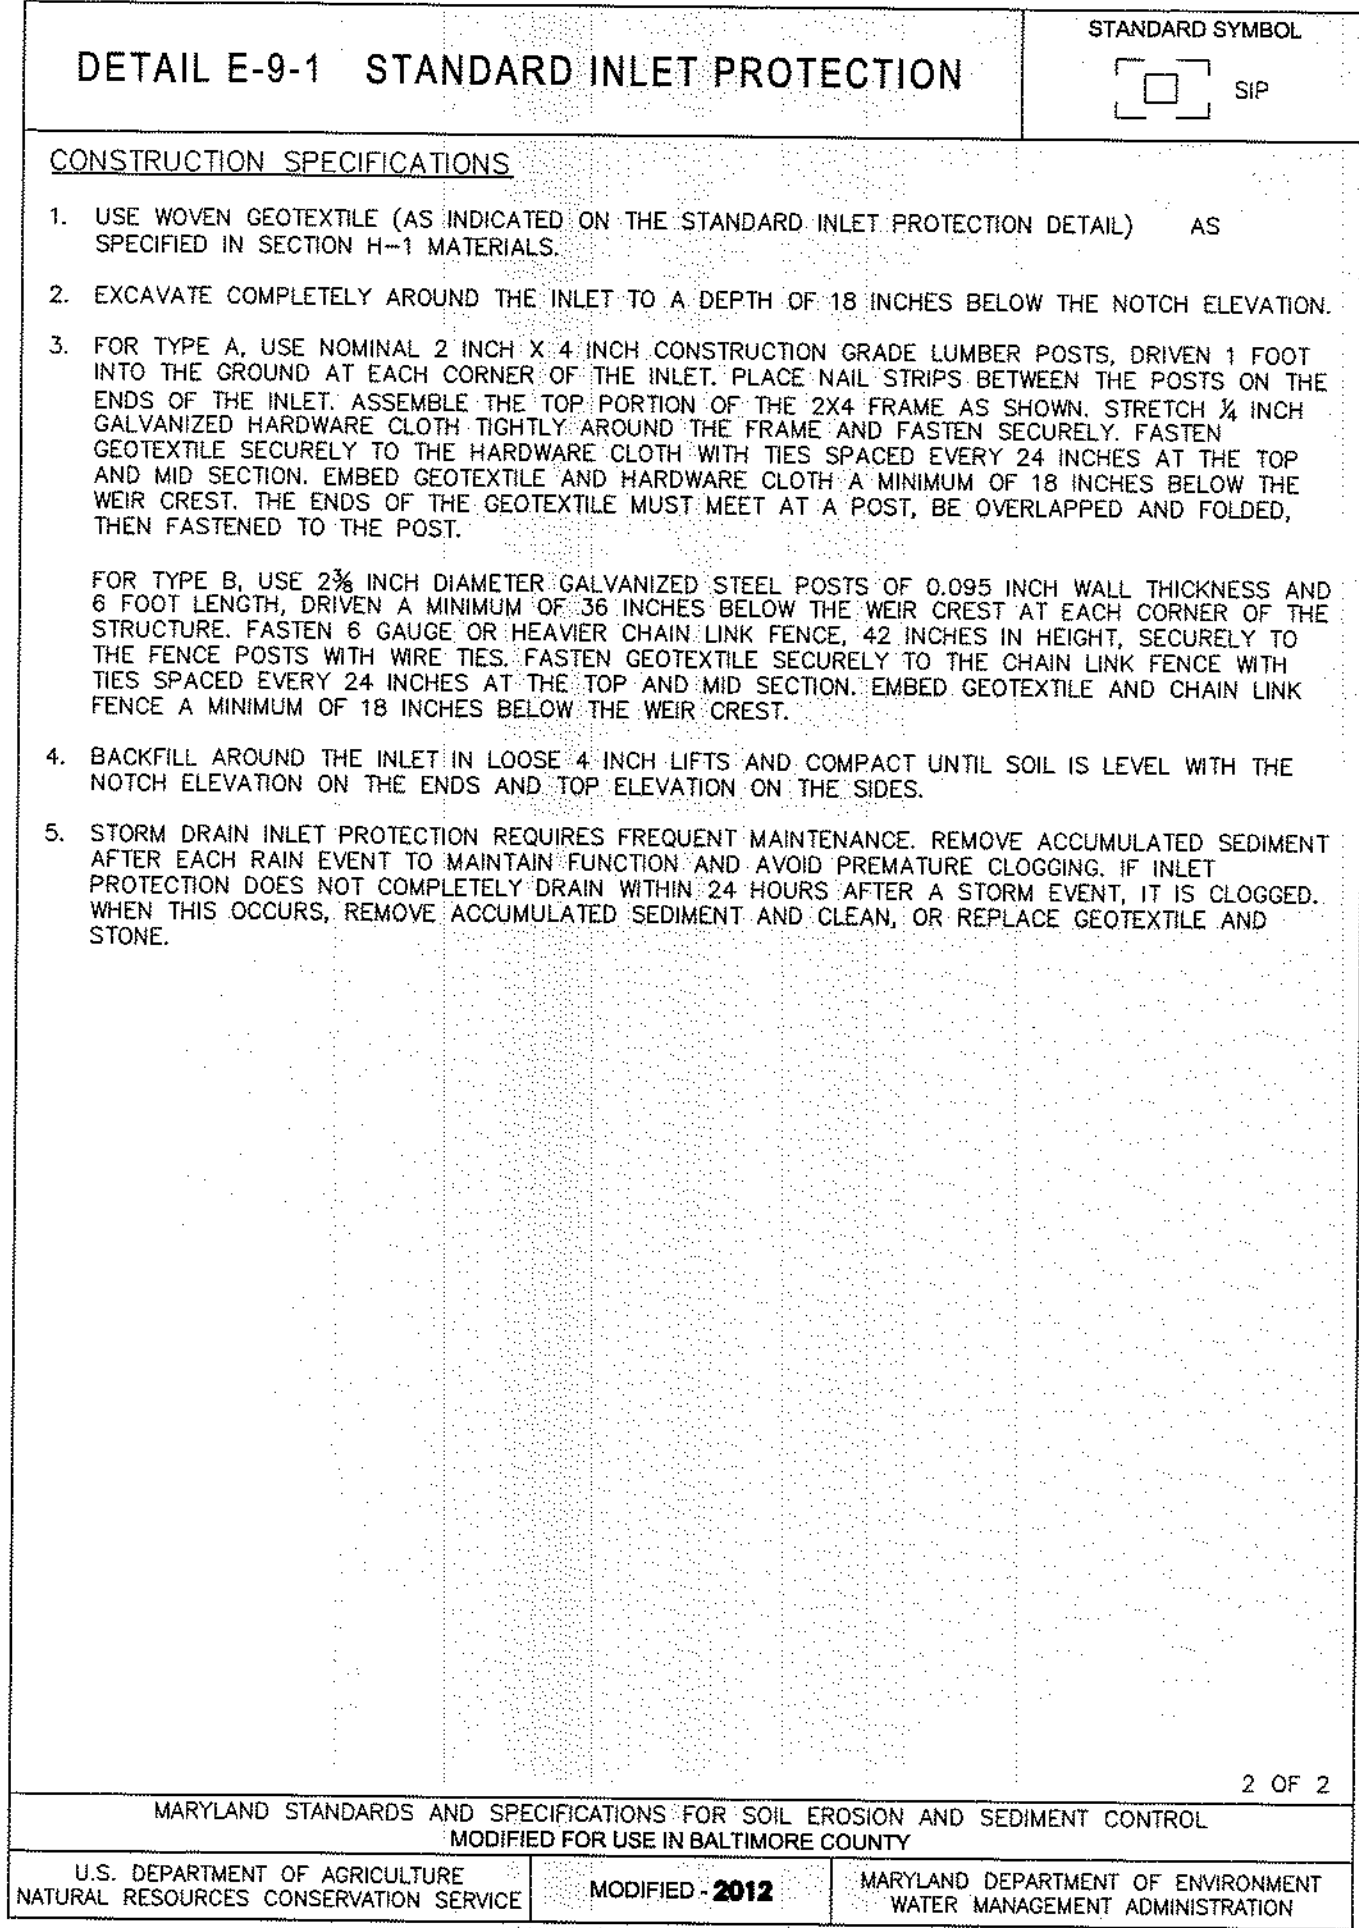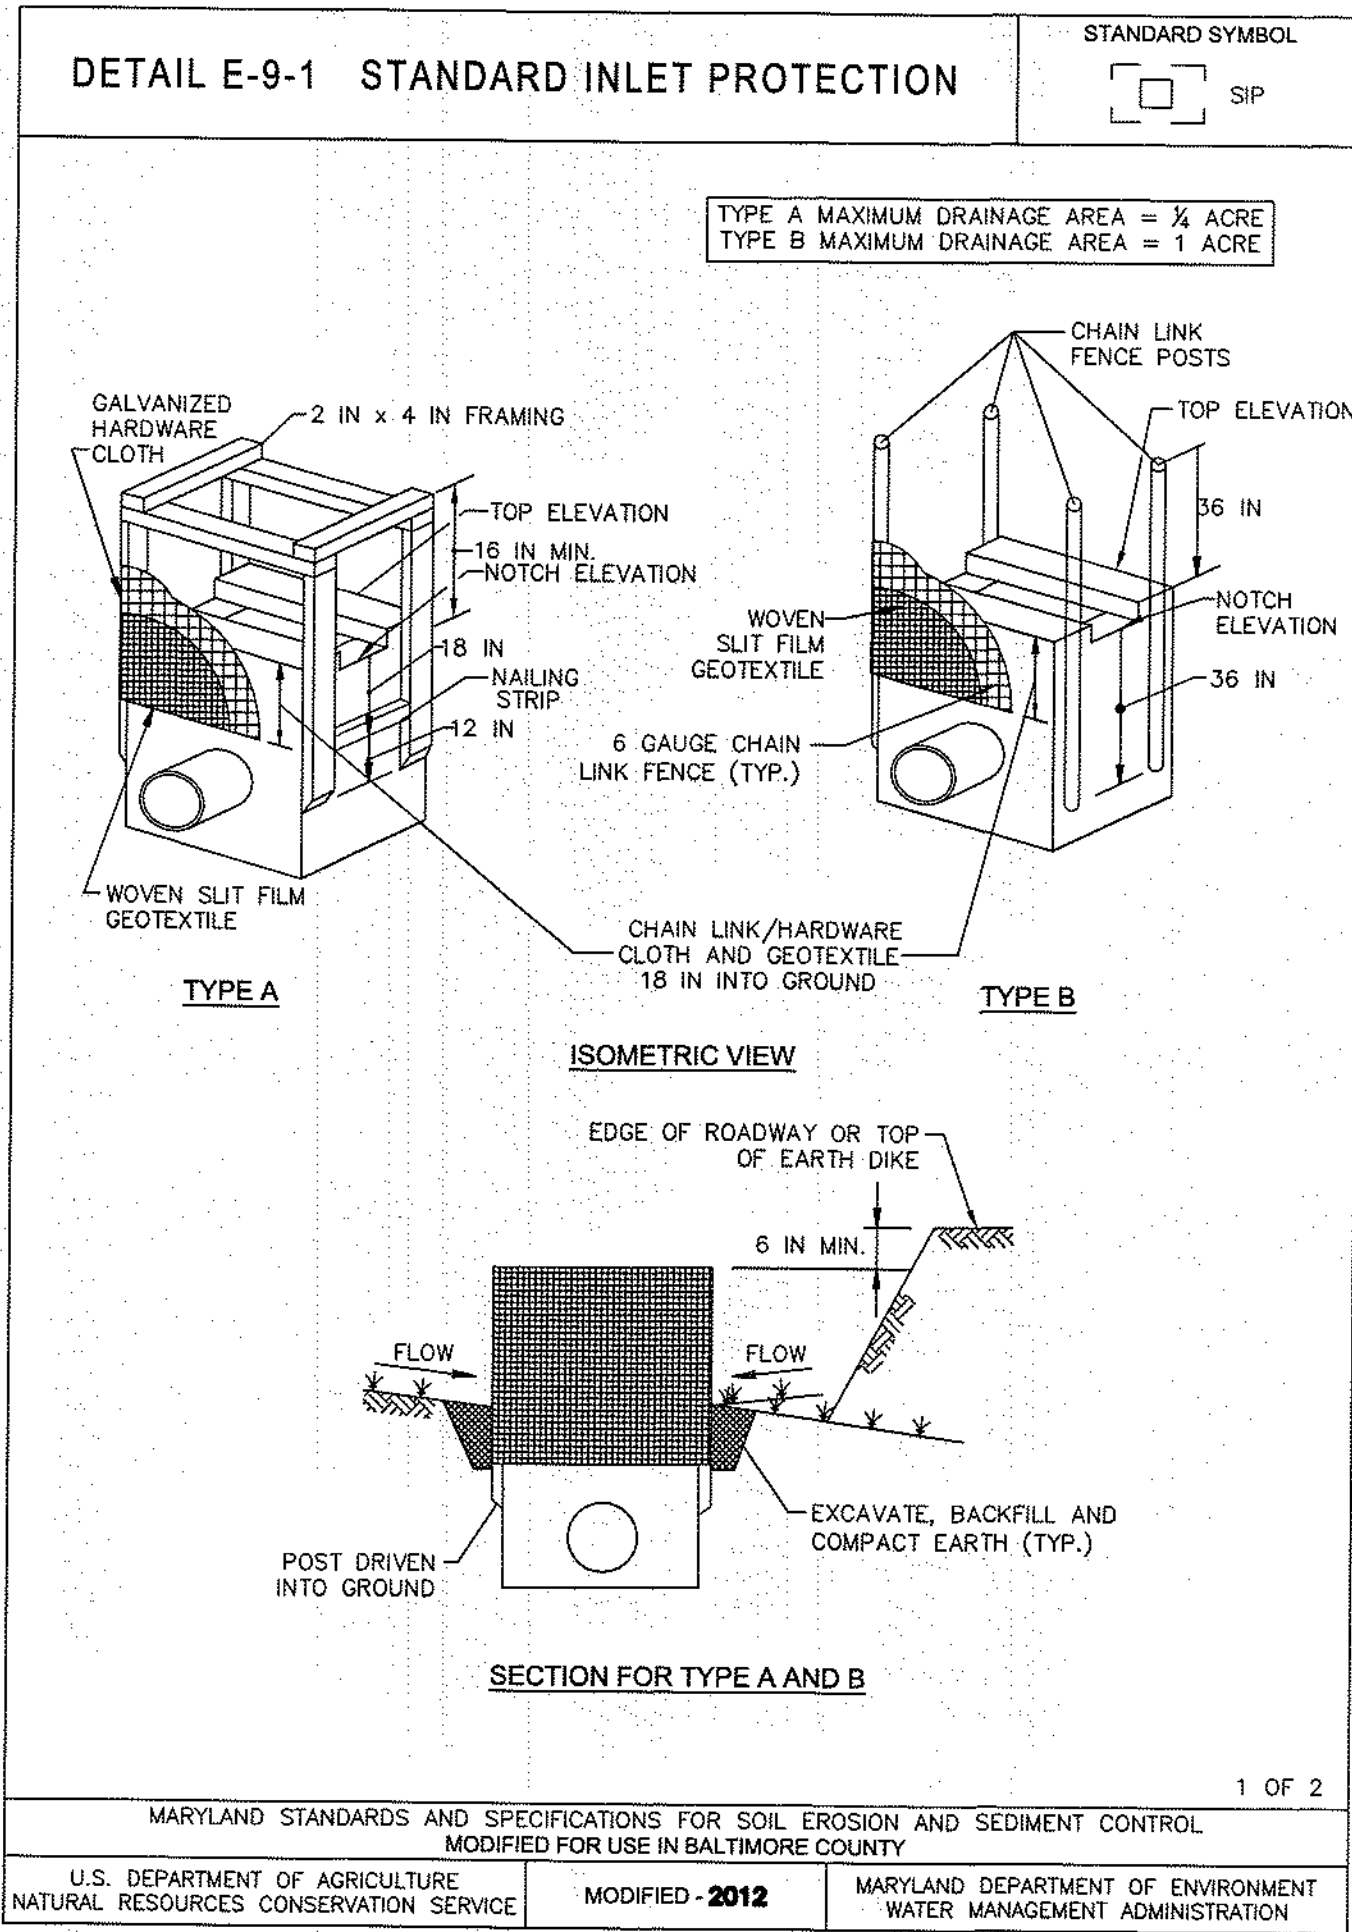

	PROFESSIONAL CERTIFICATION		AS-BUILT / REVISION	BY	DATE	P.W.A. NO.	KEY SHEET	POSITION SH	DRAWING SCALE	DEPARTMENT OF PUBLIC WORKS	
	I HEREBY CERTIFY THAT THESE DOCUMENTS WERE PREPARED OR APPROVED BY ME, AND THAT I AM DULY LICENSED PROFESSIONAL ENGINEER UNDER THE LAWS OF THE STATE OF MARYLAND.										
	LICENSE NO. 34682 EXPIRATION DATE 07/06/23		CONTRACT COMPLETION BOX								
	ENGINEER: BLAINE LINKOUS DGN BY: K.H. DWN BY: H.H. CHKD BY: B.L.		BUREAU OF ENGINEERING AND CONSTRUCTION	TRAFFIC	HIGHWAYS	STRUCTURES	STORM DRAINS	SEWER	WATER	FIELD ENGINEER	BUR. OF ENGINEERING & CONSTRUCTION

APPROVED BY:	DIRECTOR
DATE:	CHIEF

DATE: 9/7/21

FILE NO.: 242-212-307-0472

FILE NAME: C505

Signature: *AM Lamm* Facilities Chief 8/31/2021

SIGNATURE OF OWNER/DEVELOPER TITLE DATE

Baltimore County Soil Conservation District  
APPROVED FOR SEDIMENT CONTROL  
Date: 9-9-21

NOTE TO CONTRACTOR: SEDIMENT AND EROSION CONTROL SHALL BE STRICTLY ENFORCED.

OWNER  
PROPERTY MANAGEMENT, CAPITAL SERVICES  
12200 LONG GREEN PIKE  
GLEN ARM, MD 21057  
BRIAN MCKINLEY  
410-887-2915  
SITE ADDRESS:  
323 SOLLERS POINT RD, DUNDALK, MD 21222  
COORDINATES SHOWN HEREON ARE REFERRED TO THE MARYLAND STATE PLANE COORDINATE SYSTEM, NAD 83 (1983). ELEVATIONS SHOWN HEREON ARE REFERRED TO THE NORTH AMERICAN VERTICAL DATUM OF 1988 (NAVD 88).

CONTRACT COMPLETION BOX	
CONTRACTOR:	
DATE COMPLETED:	
INSPECTOR:	
PIPE MATERIAL (Pressure Only):	


SHEET DESIGNATION	CONTRACT NUMBER
2021-2881	22005 POO
JOB ORDER NUMBER	
242-212-307-0472	
SHEET 13 OF 15	
DRAWING NUMBER	
C505	
FILE NO.:	

COUNCILMATIC DISTRICT: 7  
CONGRESSIONAL DISTRICT: 2  
LEGISLATIVE DISTRICT: 6  
ELECTION DIST. NO.: 12c7

BALTIMORE COUNTY OFFICE OF BUDGET AND FINANCE, PROPERTY MANAGEMENT  
FIELD, TRACK, AND DRAINAGE REPLACEMENT  
EROSION AND SEDIMENT CONTROL DETAILS  
SOLLERS POINT MULTIPURPOSE CENTER  
323 SOLLERS POINT RD.  
DUNDALK, MD 21222

SUBDIVISION: SOLLERS POINT



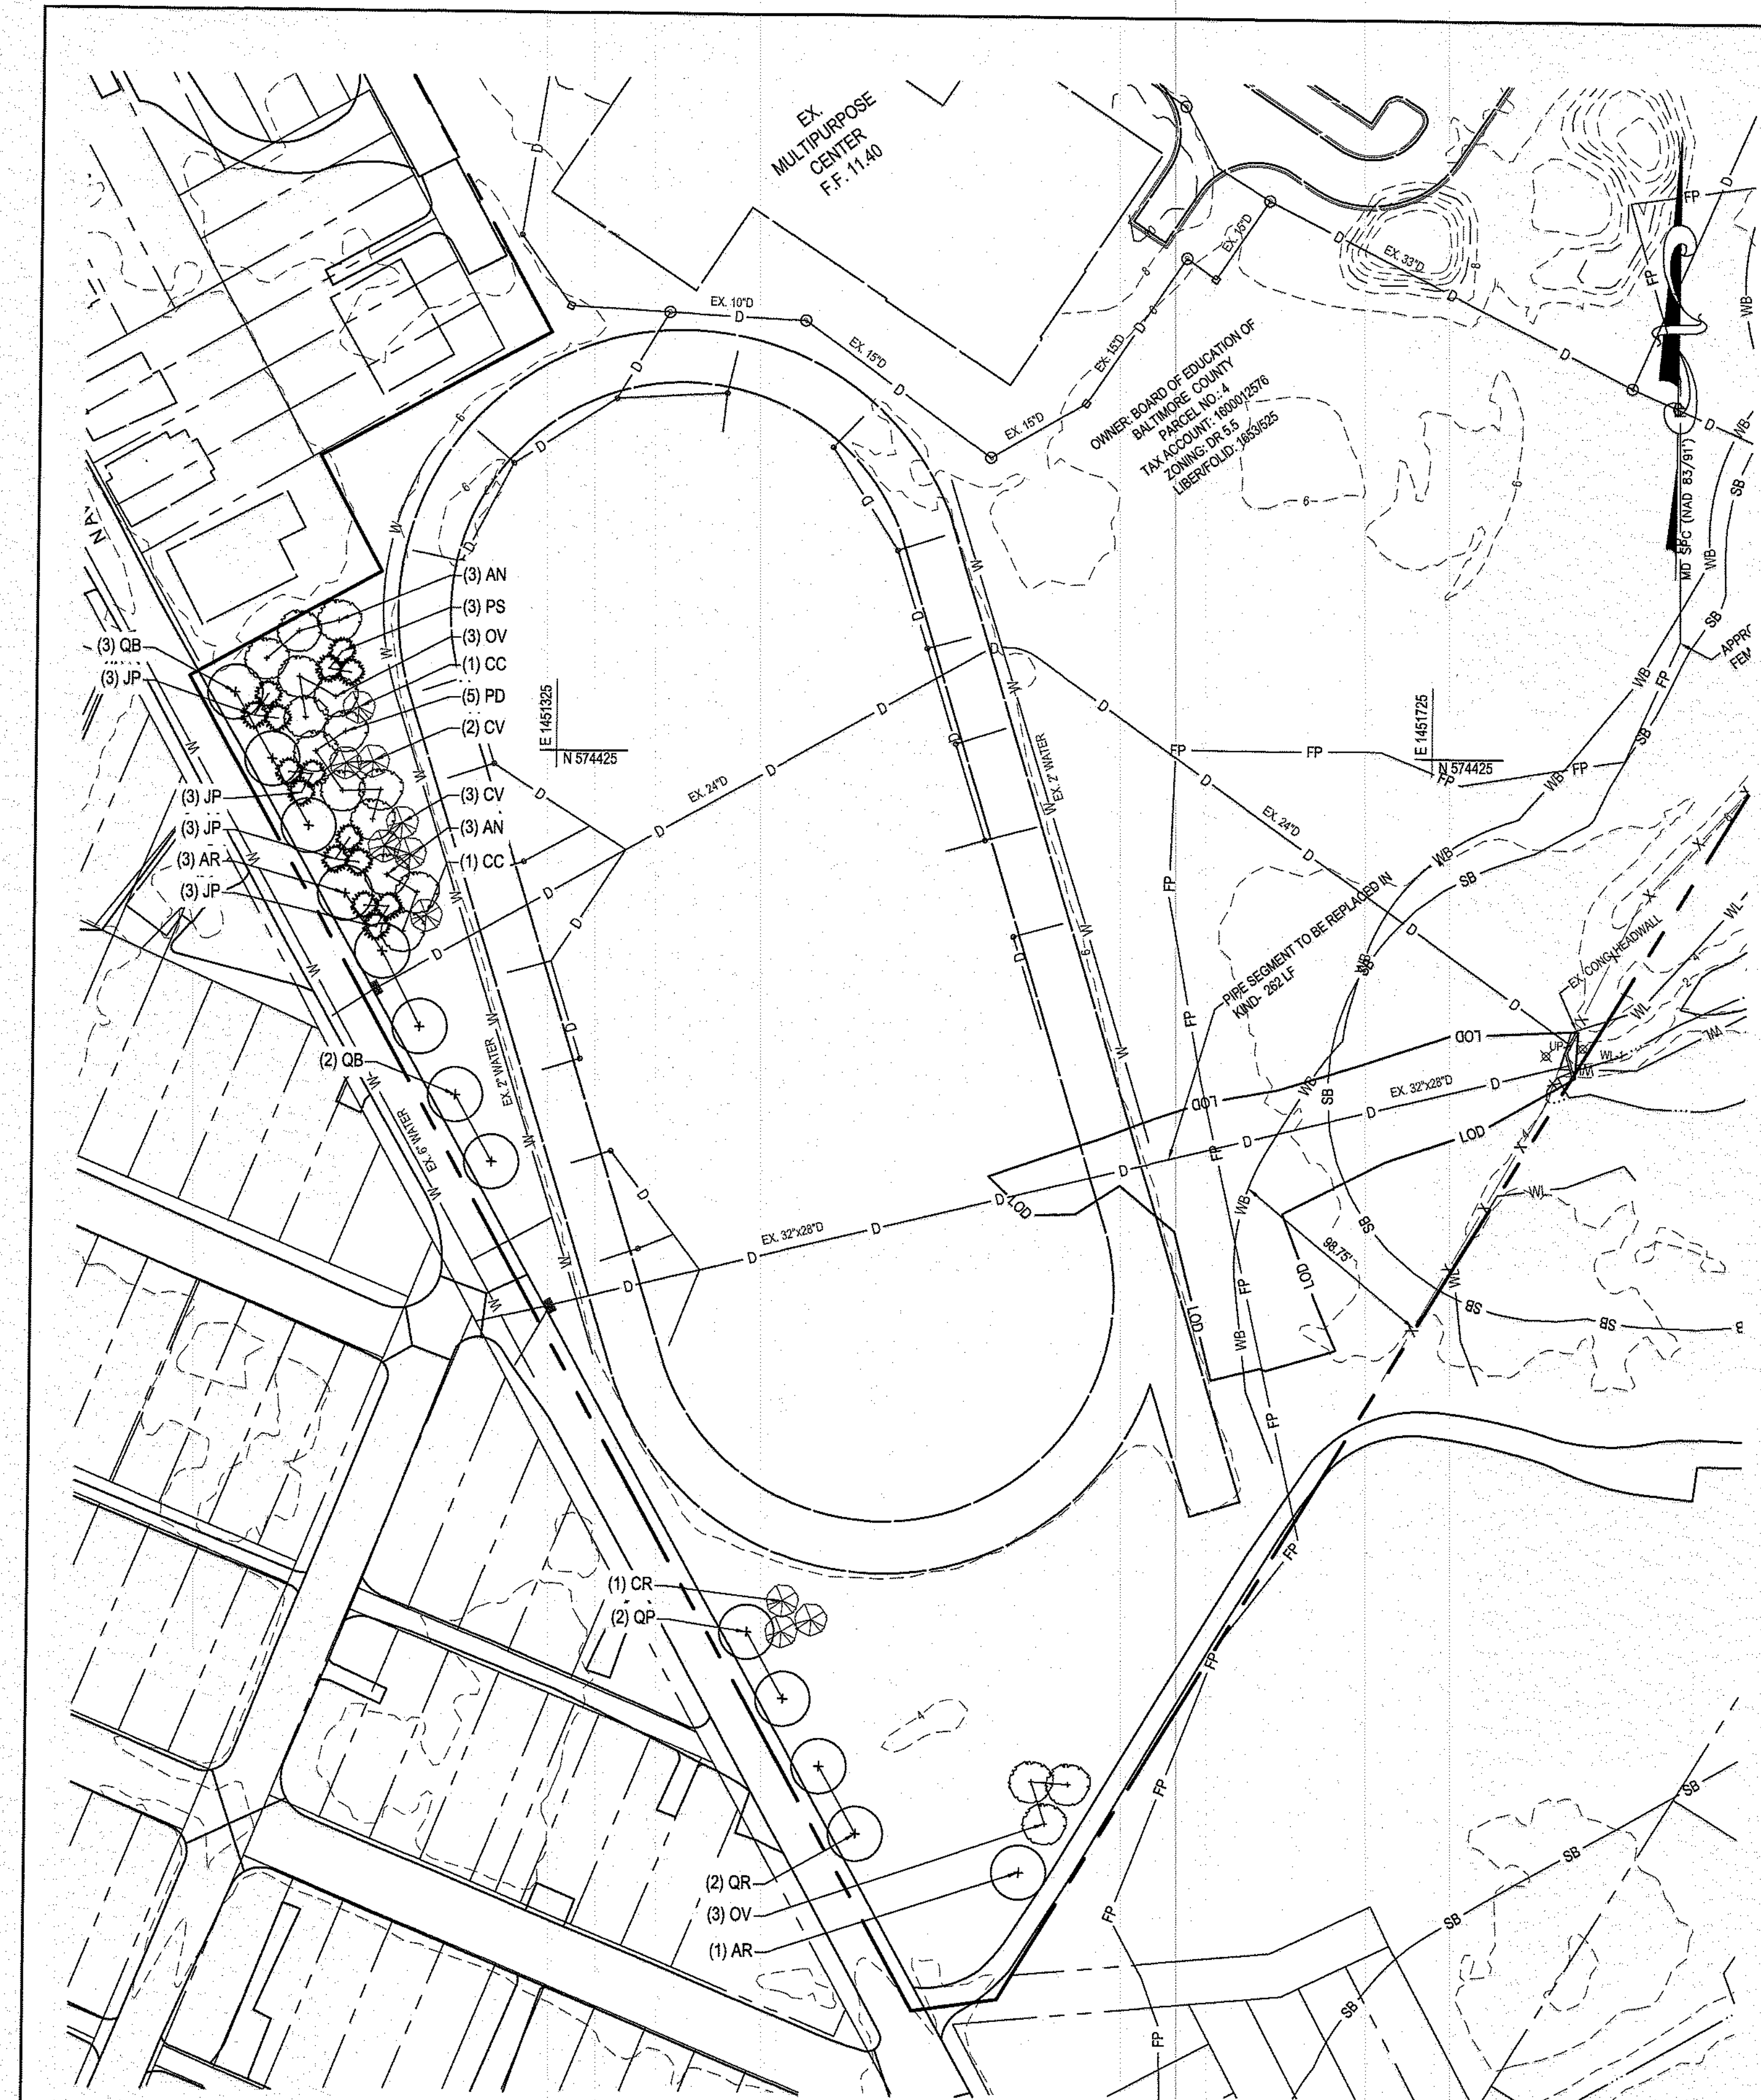

#### LEGEND

BUILDING	EXISTING
PAVING	EX. PAVING
CONCRETE WALK	EX. CONC.
PROPERTY LINE	---
EASEMENT	---
CURB	---
FENCE	X
CONTOUR	---
SPOT ELEVATION	x 14.85
STORM DRAIN	D
SANITARY	SS
WATER	W
ELECTRIC	E
GAS	G
STREAM BUFFER	SB
CENTER LINE	---
COMMUNICATIONS	T
MANHOLE	⊙ ⊙ ⊙
INLET	□
STREET LIGHT	☆ LP
POWER POLE	⚡ PP
WATER VALVE	⊕ WV
GAS VALVE	⊕ GV
FIRE HYDRANT	⊕ FH
SOIL LINE	M&B (C)
LIMIT OF DISTURBANCE	LOD
FLOODPLAIN	FP
WETLAND	WL
WETLAND BUFFER	WB

#### MASTER PLANT SCHEDULE

Key	Qty.	Botanical Name	Common Name	Size (Min.)	Root	Remarks
<b>Street Deciduous Trees</b>						
AR	4	Acer rubrum 'Somerset'	Somerset Red Maple	2.0" Cal.	B&B	As Shown
QB	5	Quercus bicolor	Swamp White Oak	2.0" Cal.	B&B	As Shown
QP	2	Quercus palustris	Pin Oak	2.0" Cal.	B&B	As Shown
QR	2	Quercus Rubra	Red Oak	2.0" Cal.	B&B	As Shown
	13	Total				
<b>Buffer Deciduous Trees</b>						
AN	6	Acer negundo	Box Elder	2.0" Cal.	B&B	As Shown
OV	6	Ostrya virginiana	American Hophornbeam	2.0" Cal.	B&B	As Shown
PD	5	Populus deltoides	Cotton Wood	2.0" Cal.	B&B	As Shown
	17	Total				
<b>Ornamental Trees</b>						
CR	3	Cornus florida	Flowering Dogwood	1.5" Cal.	B&B	Multi-Stem, 3 Cane Match
CC	2	Cercis canadensis	Eastern Redbud	1.5" Cal.	B&B	Multi-Stem, 3 Cane Match
CV	5	Crataegus viridis 'Winter King'	Green Hawthorn Winter King	1.5" Cal.	B&B	Single Leader
	10	Total				
<b>Evergreen Trees</b>						
JP	12	Juniperus virginiana	Eastern Red Cedar	1.5" Cal.	B&B	As Shown
PS	3	Pinus strobus	White Pine	1.5" Cal.	B&B	As Shown
	15	Total				

#### CRITICAL AREA NOTES:

- PROPERTY AREA: 12.924 AC
- PROJECT LIMITS OF DISTURBANCE: .33 AC (100% WITHIN CRITICAL AREA)
- AFFORESTATION REQUIREMENT: 1:1 MITIGATION = 7,841 SF
- PLANTING CREDITS REQUIRED:
  - CANOPY STREET TREES (2 IN. CAL.) - 200 SQFT CREDIT
  - CANOPY BUFFER TREES (2 IN. CAL.) - 100 SQFT CREDIT
  - UNDERSTORY TREES (2 IN. CAL.) - 75 SQFT CREDIT
  - EVERGREEN TREES (2 IN. CAL.) - 75 SQFT CREDIT
- PROPOSED ON-SITE PLANTING:
  - 30 - CANOPY STREET TREES (2 IN. CAL.) (30\*200 SQFT = 6,000 SQFT)
  - 10 - UNDERSTORY TREES (1.5 IN. CAL.) (10\*75 SQFT = 750 SQFT)
  - 15 - EVERGREEN TREES (1.5 IN. CAL.) (15\*75 SQFT = 1,125 SQFT)


TOTAL CREDITED COVERAGE: 7,875 SQFT

#### PLANTING GENERAL NOTES:


- ALL PLANT MATERIAL SHALL BE IN ACCORDANCE WITH THE LATEST EDITION OF THE AMERICAN STANDARD FOR NURSERY STOCK ANSI Z60.
- MAINTENANCE PERIOD: THE LANDSCAPE CONTRACTOR SHALL BE RESPONSIBLE FOR MAINTAINING PLANTINGS BY PRUNING, CULTIVATING, WATERING, WEEDING, FERTILIZING, MULCHING, RESTORING PLANTING SAUCERS, ADJUSTING AND REPAIRING TREE-STABILIZATION DEVICES, RESETTling TO PROPER GRADES OR VERTICAL POSITION, AND PERFORMING OTHER OPERATIONS AS REQUIRED TO ESTABLISH HEALTHY, VIABLE PLANTINGS FOR A TWO (2) YEARS, STARTING FROM DATE OF PLANTING COMPLETION.
- ALL TREES WILL BE PLANTED WITH PROPER PLANTING PRACTICES, STAKED WITH 6" TREE STAKES, WIRE AND A PROTECTIVE HOSE.
- TREES WILL RECEIVE COMPOST AMENDMENT, HARDWOOD BARK MULCH AT A DEPTH OF 2-3" AND WILL BE FERTILIZED WITH PHC 4-7-4 FERTILIZER WITH MYCORRHIZAL FUNGI AND A WATER ABSORBENT GEL.
- APPLY WEED-CONTROL BARRIERS OF NONWOVEN GEOTEXTILE FILTER FABRIC OR COMPOSITE FABRIC.
- A TREE SAUCER WILL BE CREATED TO HELP RETAIN WATER.
- TREES TO BE PLANTED ACCORDING TO PLANTING SEASON (FALL: MID AUGUST - MID OCTOBER, SPRING: MID MARCH - MID JUNE) AND WITH A RANDOM PATTERN.

#### PLANTING LEGEND:

- DECIDUOUS SHADE TREE
- BUFFER DECIDUOUS SHADE TREE
- DECIDUOUS ORNAMENTAL TREE
- EVERGREEN TREE

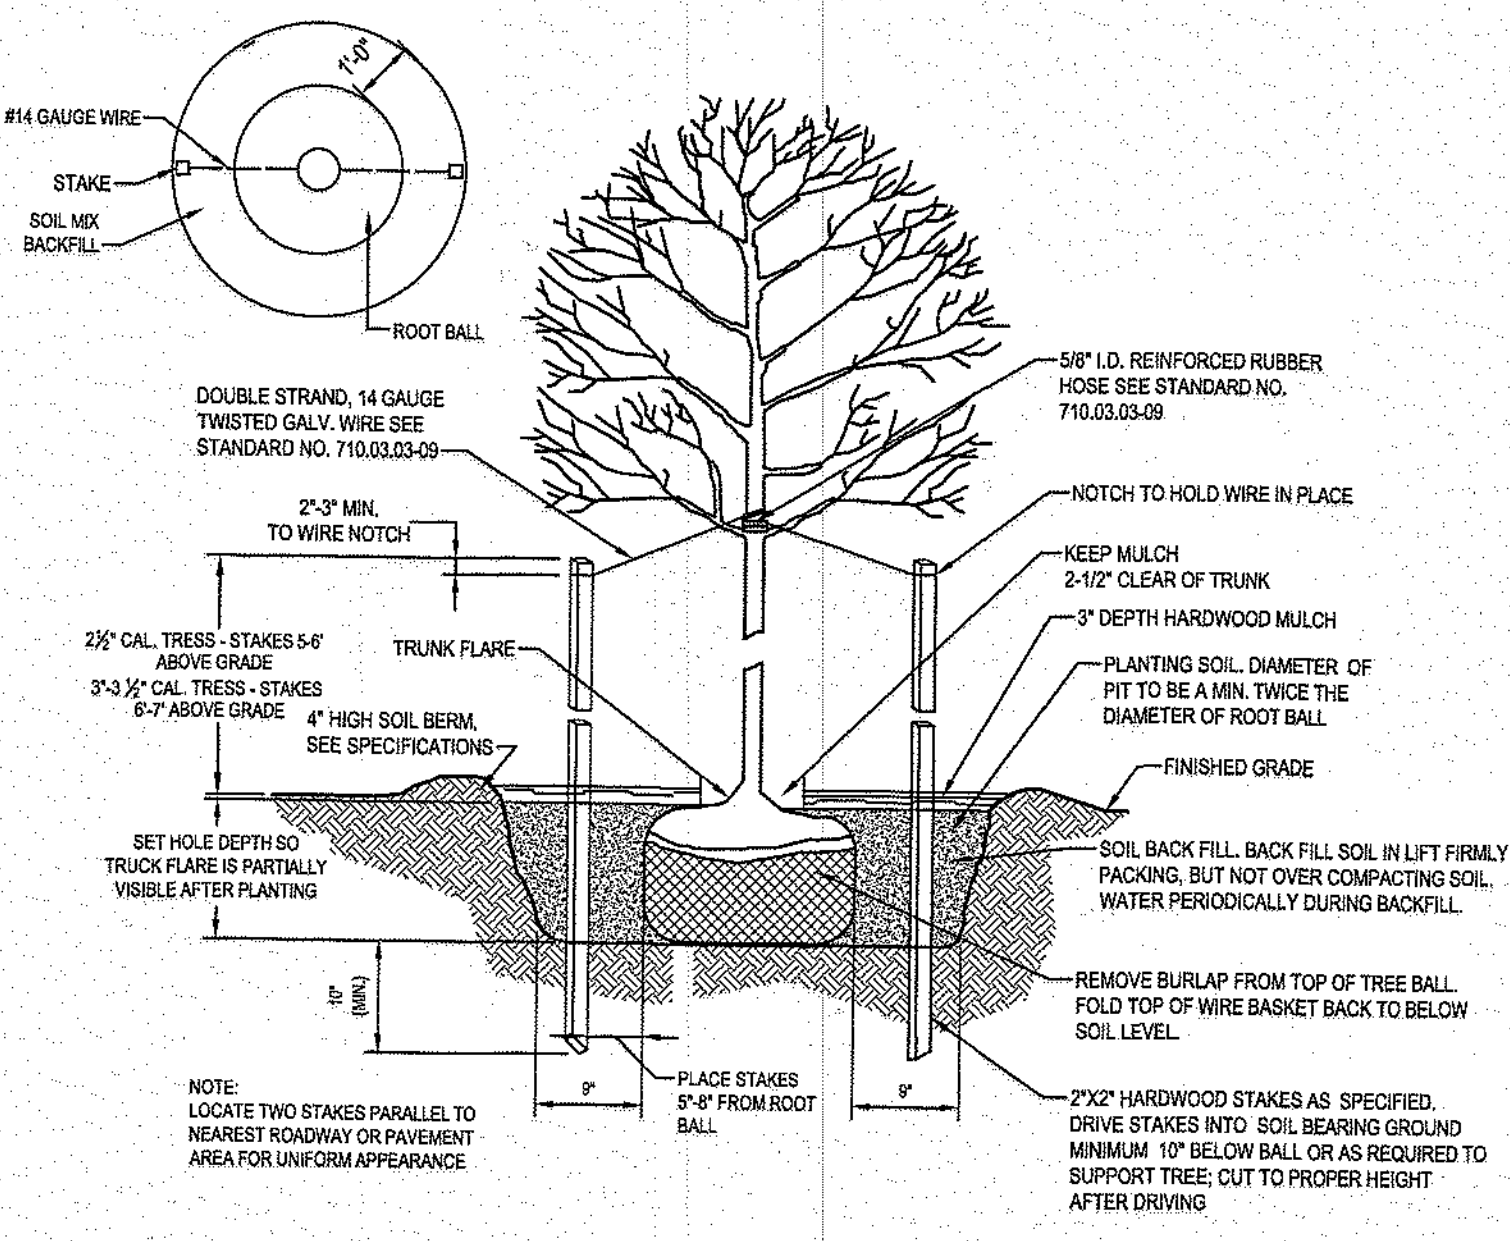


ELEVATION  
DECIDUOUS TREE  
NOT TO SCALE

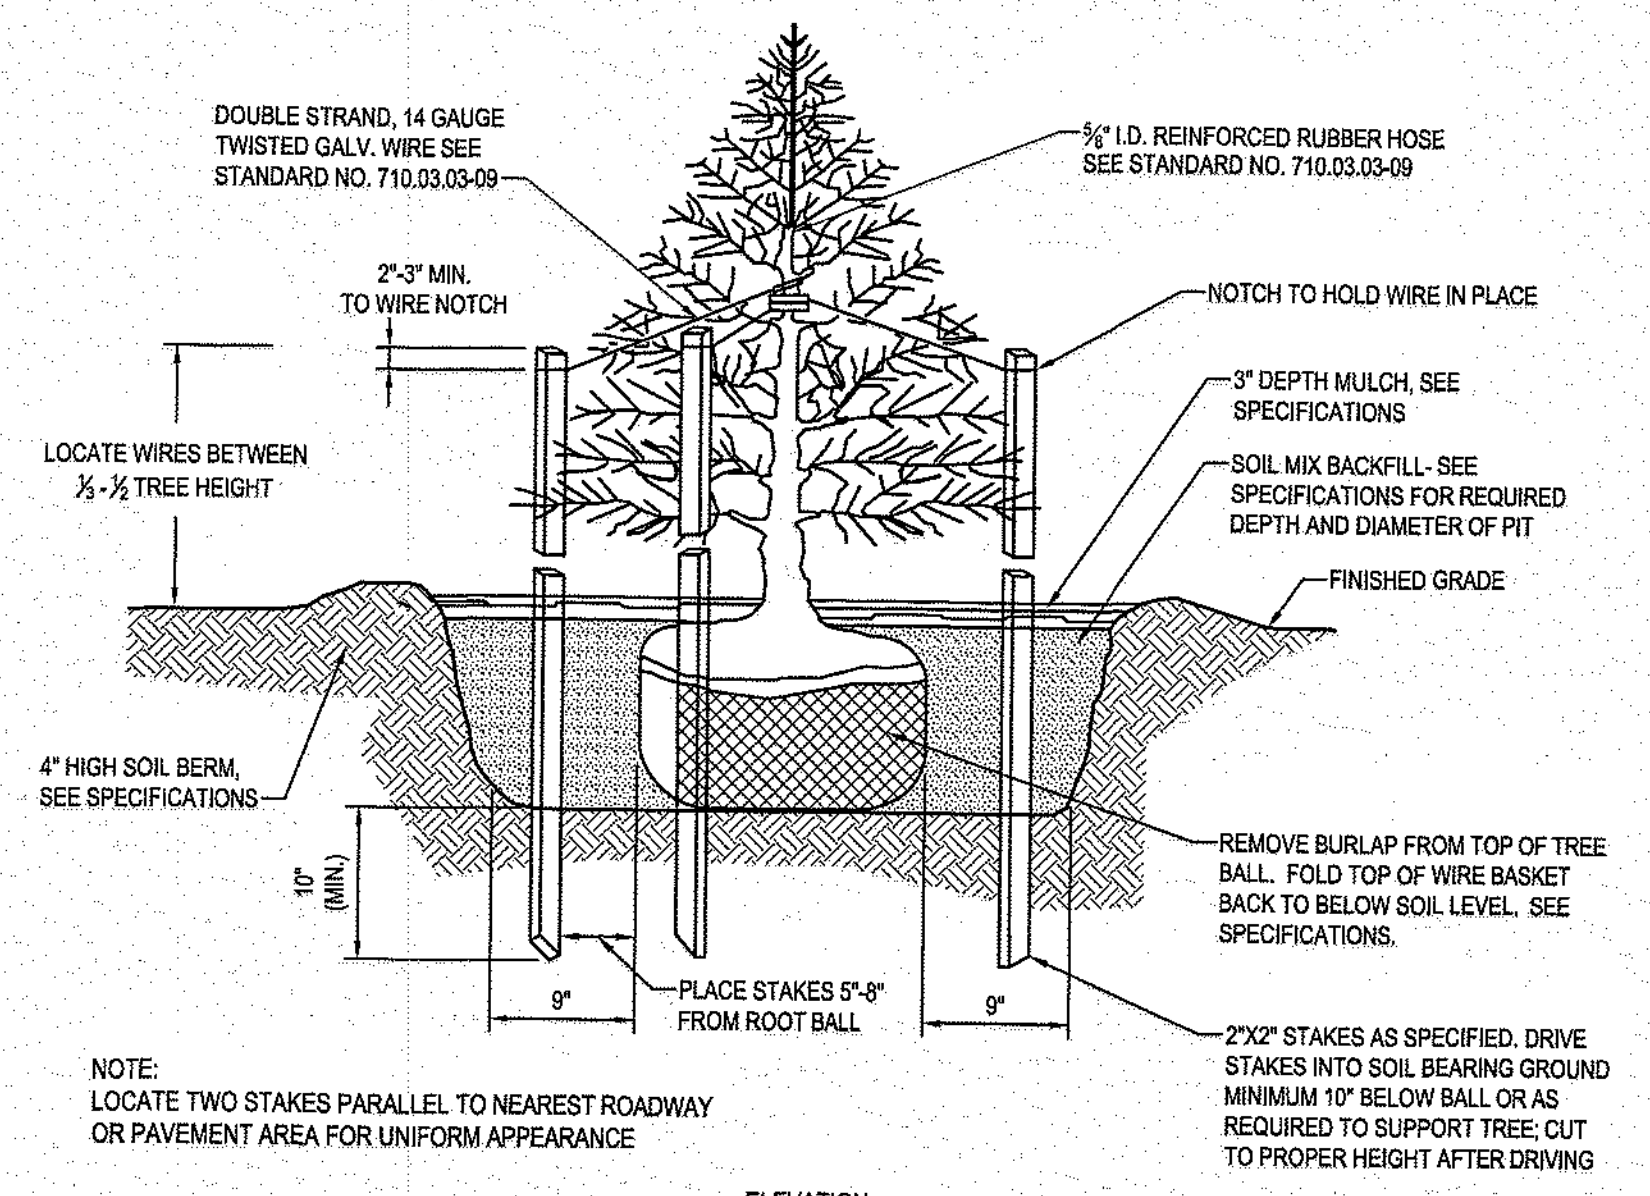

ELEVATION  
EVERGREEN TREE  
NOT TO SCALE

AN ALTERNATIVES ANALYSIS WAS APPROVED BY THE BALTIMORE COUNTY DEPARTMENT OF ENVIRONMENTAL PROTECTION AND SUSTAINABILITY ON JULY 23, 2020. CONDITIONS WERE PLACED ON THIS APPROVAL TO REDUCE WATER QUALITY IMPACTS INCLUDING RESTORATION OF TEMPORARILY DISTURBED TIDAL WETLAND BUFFER.

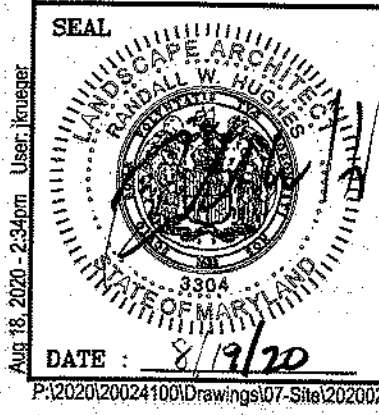

PROFESSIONAL CERTIFICATION		AS-BUILT / REVISION		BY	DATE	P.W.A. NO.	KEY SHEET	POSITION SHI	DRAWING SCALE	DEPARTMENT OF PUBLIC WORKS	
I HEREBY CERTIFY THAT THESE DOCUMENTS WERE PREPARED OR APPROVED BY ME, AND THAT I AM A DULY LICENSED PROFESSIONAL ENGINEER UNDER THE LAWS OF THE STATE OF MARYLAND.									PLAN SCALE:	APPROVED BY: _____ DIRECTOR	
LICENSE NO. _____ EXPIRATION DATE _____									PROFILE SCALE:	DATE: _____	
DGN BY: J.K.		BUREAU OF ENGINEERING AND CONSTRUCTION		TRAFFIC	HIGHWAYS	STRUCTURES	STORM DRAINS	SEWER	WATER	FIELD ENGINEER	BUR. OF ENGINEERING & CONSTRUCTION
DWN BY: H.H.		REVIEWED BY:									APPROVED BY: _____ CHIEF
CHKD BY: R.L.		DATE REVIEWED:									DATE: _____

SIGNATURE OF OWNER/DEVELOPER: *A.M. Lown* TITLE: *FACILITIES CHIEF* DATE: *8/31/2021*

BALTIMORE COUNTY DEPARTMENT OF ENVIRONMENTAL PROTECTION AND SUSTAINABILITY  
BUFFER MANAGEMENT PLAN APPROVAL  
Approval by: *Charlotte Lown* DATE: *9/1/20*  
Buffer management Plan # *CA-20-030*


CAUTION: IF THIS DRAWING IS A REDUCTION, USE THE GRAPHIC SCALES.  
1"=50'-0"

BALTIMORE COUNTY DEPARTMENT OF PUBLIC WORKS BUREAU OF ENGINEERING & CONSTRUCTION  
STORM DRAIN LINE REPAIR  
BUFFER MANAGEMENT PLAN  
SOLLERS POINT MULTIPURPOSE CENTER  
323 SOLLERS POINT RD.  
DUNDALK, MD 21222  
SUBDIVISION: SOLLERS POINT MULTI-PURPOSE CENTER  
COUNCILMATIC DISTRICT: 7  
CONGRESSIONAL DISTRICT: 2  
LEGISLATIVE DISTRICT: 6  
ELECTION DIST. NO.: 12c7

CONTRACT COMPLETION BOX	
CONTRACTOR:	
DATE COMPLETED:	
INSPECTOR:	
PIPE MATERIAL (Pressure Only)	

SHEET DESIGNATION	CONTRACT NUMBER
2021-2882	22005 POO
JOB ORDER NUMBER	
242-212-307-0472	
SHEET 14 OF 15	
DRAWING NUMBER	
C506	
FILE NO.:	



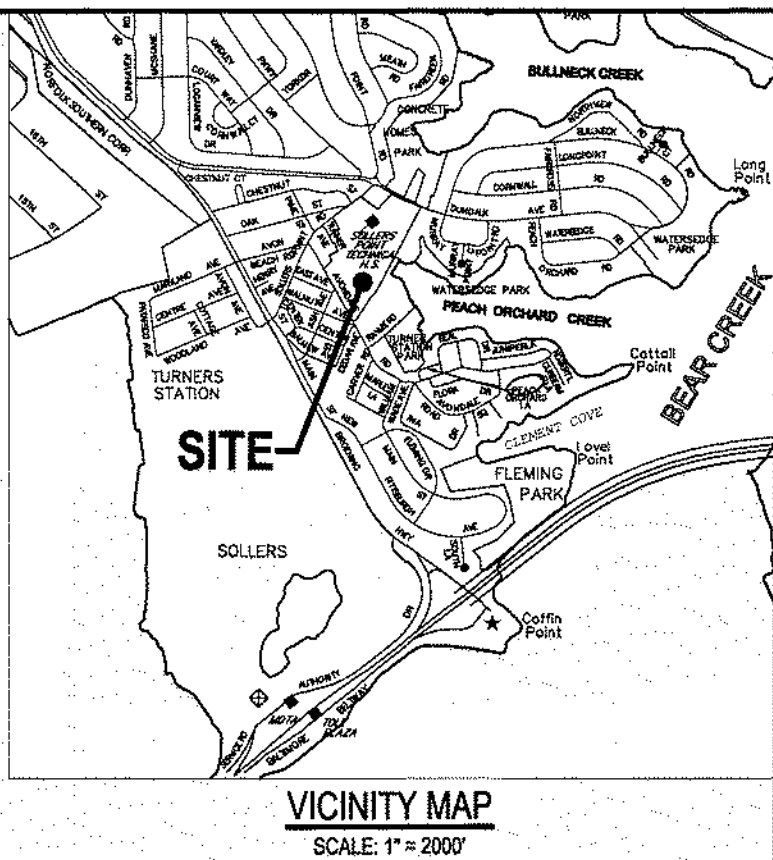



LEGEND

BUILDING	EXISTING
PAVING	EX. BLDG.
CONCRETE WALK	EX. PAVING
PROPERTY LINE	EX. CONC.
EASEMENT	
CURB	
FENCE	X
CONTOUR	15
SPOT ELEVATION	x 14.85
STORM DRAIN	D
SANITARY	SS
WATER	W
ELECTRIC	E
GAS	G
STREAM BUFFER	SB
CENTER LINE	
COMMUNICATIONS	T
MANHOLE	⊙ ⊙ ⊙
INLET	□
STREET LIGHT	☆ LP
POWER POLE	PP
WATER VALVE	⊕ WV
GAS VALVE	⊕ GV
FIRE HYDRANT	⊕
SOIL LINE	MkC (C)
LIMIT OF DISTURBANCE	UuB (D)
FLOODPLAIN	FP
WETLAND	WL
WETLAND BUFFER	WB

GENERAL NOTES

- THIS PLAN IS BASED UPON GIS DATA FROM BALTIMORE COUNTY, DOWNLOADED IN MAY, 2020 AND REFLECTS SITE CONDITIONS AS OF THAT DATE.
- COORDINATES SHOWN HEREON ARE REFERENCED TO THE MARYLAND STATE PLANE COORDINATE SYSTEM, NAD 83(2011).
- ELEVATIONS SHOWN HEREON ARE REFERRED TO THE NORTH AMERICAN VERTICAL DATUM OF 1988 (NAVD 88).
- ADDITIONAL SPOT ELEVATIONS RESIDE IN THE ELECTRONIC VERSION OF THIS DRAWING BUT ARE NOT PLOTTED HEREON.
- THE LOCATION OF EXISTING UNDERGROUND UTILITIES IS SHOWN IN AN APPROXIMATE WAY ONLY. THE DESCRIPTION OF THE UNDERGROUND UTILITIES AS SHOWN HEREON WERE BASED SOLELY UPON GIS DATA AND HAVE NOT BEEN COMPARED TO OR VERIFIED WITH RECORD UTILITY DRAWINGS OR FIELD TEST PITS. THE SIZE, TYPE AND LOCATION OF THE UTILITY LINES SHOULD BE VERIFIED BY THE USER OF THIS DRAWING. NO UTILITY DESIGNATION WAS COMPLETED FOR THIS PROJECT.
- THE CONTRACTOR SHALL BE RESPONSIBLE TO VERIFY THE EXACT LOCATION OF ALL EXISTING UNDERGROUND UTILITIES BEFORE COMMENCING ANY WORK. CONTRACTOR AGREES TO BE FULLY RESPONSIBLE FOR THE COST OF ANY AND ALL DAMAGES WHICH OCCUR AS A RESULT OF A FAILURE TO EXACTLY LOCATE AND PRESERVE ANY AND ALL EXISTING UTILITIES TO REMAIN.
- IT IS THE CONTRACTOR'S RESPONSIBILITY TO FIELD VERIFY ACTUAL SITE CONDITIONS PRIOR TO THE START OF ANY WORK. THERE IS NO WARRANTY OR GUARANTEE ON THE COMPLETENESS OR CORRECTNESS OF THE EXISTING CONDITION INFORMATION. ANY DISCREPANCY FOUND SHALL BE BROUGHT TO THE IMMEDIATE ATTENTION OF THE ARCHITECT/ENGINEER PRIOR TO THE START OF ANY WORK.
- THE CONTRACTOR SHALL BE RESPONSIBLE FOR NOTIFYING "MISS UTILITY" AT 1-800-257-7777 THREE DAYS PRIOR TO THE START OF ANY EXCAVATION WORK.
- THE CONTRACTOR SHALL VERIFY ALL EXISTING UTILITY INVERTS AND CLEARANCES FROM NEW WORK PRIOR TO START OF ANY WORK.
- THE WORDS "CERTIFY" OR "CERTIFICATION" AS USED HEREON ARE UNDERSTOOD TO BE AN EXPRESSION OF PROFESSIONAL OPINION BY THE UNDERSIGNED SURVEYOR, BASED UPON HIS BEST KNOWLEDGE, INFORMATION AND BELIEF, AS SUCH, IT DOES NOT CONSTITUTE A GUARANTEE NOR A WARRANTY, EXPRESSED OR IMPLIED.

Sollers Point Impacts - LOD - 0.33 AC	
Resource	Impact Quantity (AC)
Wetland	0.00
Wetland Buffer	0.18
Critical Area (IDA, Intensely Developed Area)	0.33
Floodplain Zone AE	0.21
Floodplain Zone X	0.12

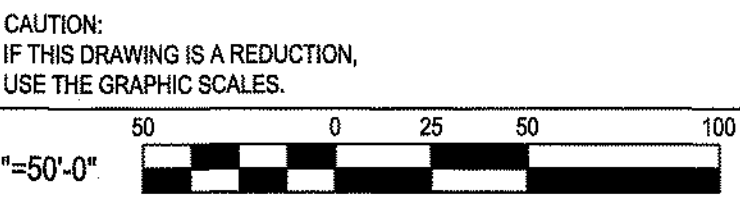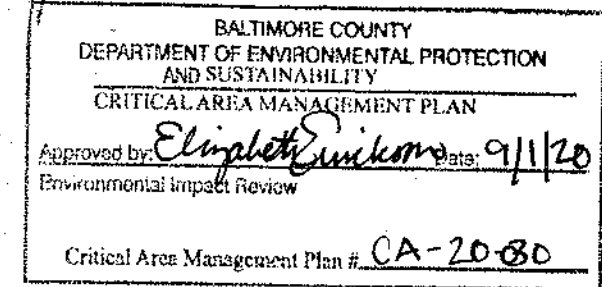

CONTRACT COMPLETION BOX	
CONTRACTOR:	
DATE COMPLETED:	
INSPECTOR:	
PIPE MATERIAL (Pressure Only):	

SHEET DESIGNATION	CONTRACT NUMBER
2021-2884	22005 POO
JOB ORDER NUMBER	
242-212-307-0472	
SHEET 15 OF 15	
DRAWING NUMBER	
C507	
FILE NO.:	
474	

PROFESSIONAL CERTIFICATION	AS-BUILT / REVISION	BY	DATE	P.W.A. NO.	KEY SHEET	POSITION SHT	DRAWING SCALE	DEPARTMENT OF PUBLIC WORKS
I HEREBY CERTIFY THAT THESE DOCUMENTS WERE PREPARED OR APPROVED BY ME, AND THAT I AM A DULY LICENSED PROFESSIONAL ENGINEER UNDER THE LAWS OF THE STATE OF MARYLAND. LICENSE NO. 34882, EXPIRATION DATE 07/08/21								
DGN BY: J.K.	BUREAU OF ENGINEERING AND CONSTRUCTION	TRAFFIC	HIGHWAYS	STRUCTURES	STORM DRAINS	SEWER	WATER	FIELD ENGINEER
DWN BY: H.N.	REVIEWED BY:							
CHKD BY: B.L.	DATE REVIEWED:							

SIGNATURE OF OWNER/DEVELOPER: *[Signature]* TITLE: FACILITIES CHIEF DATE: 8/31/2021

BALTIMORE COUNTY DEPARTMENT OF PUBLIC WORKS BUREAU OF ENGINEERING & CONSTRUCTION  
STORM DRAIN LINE REPAIR  
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